



CHICAGO PARK 541 NORTH FAIRBANKS

MULLER+MULLER architects

700 N SANGAMON T. 312.432.4180 F 312.432.4184

© 2005, Muller & Muller, Ltd.

Muller & Muller, Ltd. expressly reserves its common law copyright and other property rights in these plans. These plans are not to be reproduced, changed or copied in any form or manner whatsoever, nor are they to be assigned to any third party, without firstobtaining the expressed written consent of Muller & Muller, P.C., Ltd

> **INFRASTRUCTURE** ENGINEERING | INCORPORAT

33 West Monroe | Suite 1540 | Chicago, IL 60603 P 312 425 9560 | F 312 425 9564 | www.infrastructure-eng.com

7 10.27.2009 ISSUED FOR ADDENDUM #4

6 | 10.21.2009 | ISSUED FOR ADDENDUM #2 | 10.20.2009 | ISSUED FOR ADDENDUM #1


4 | 9.25.2009 | ISSUED FOR BID 3 | 9.21.2009 | ISSUED FOR PERMIT/95% DESIGN

2 | 9.04.2009 | ISSUED FOR 90% DESIGN 1 | 3.31.2009 | ISSUED FOR 30% DESIGN

40TH STREET COMFORT STATION CHICAGO, IL

UTILITY PLAN AND PROFILE

DRAWN: RP	SHEET NO
CHECKED: HG	044
APPROVED:	C4.1
IOB NO. 09 01 08	

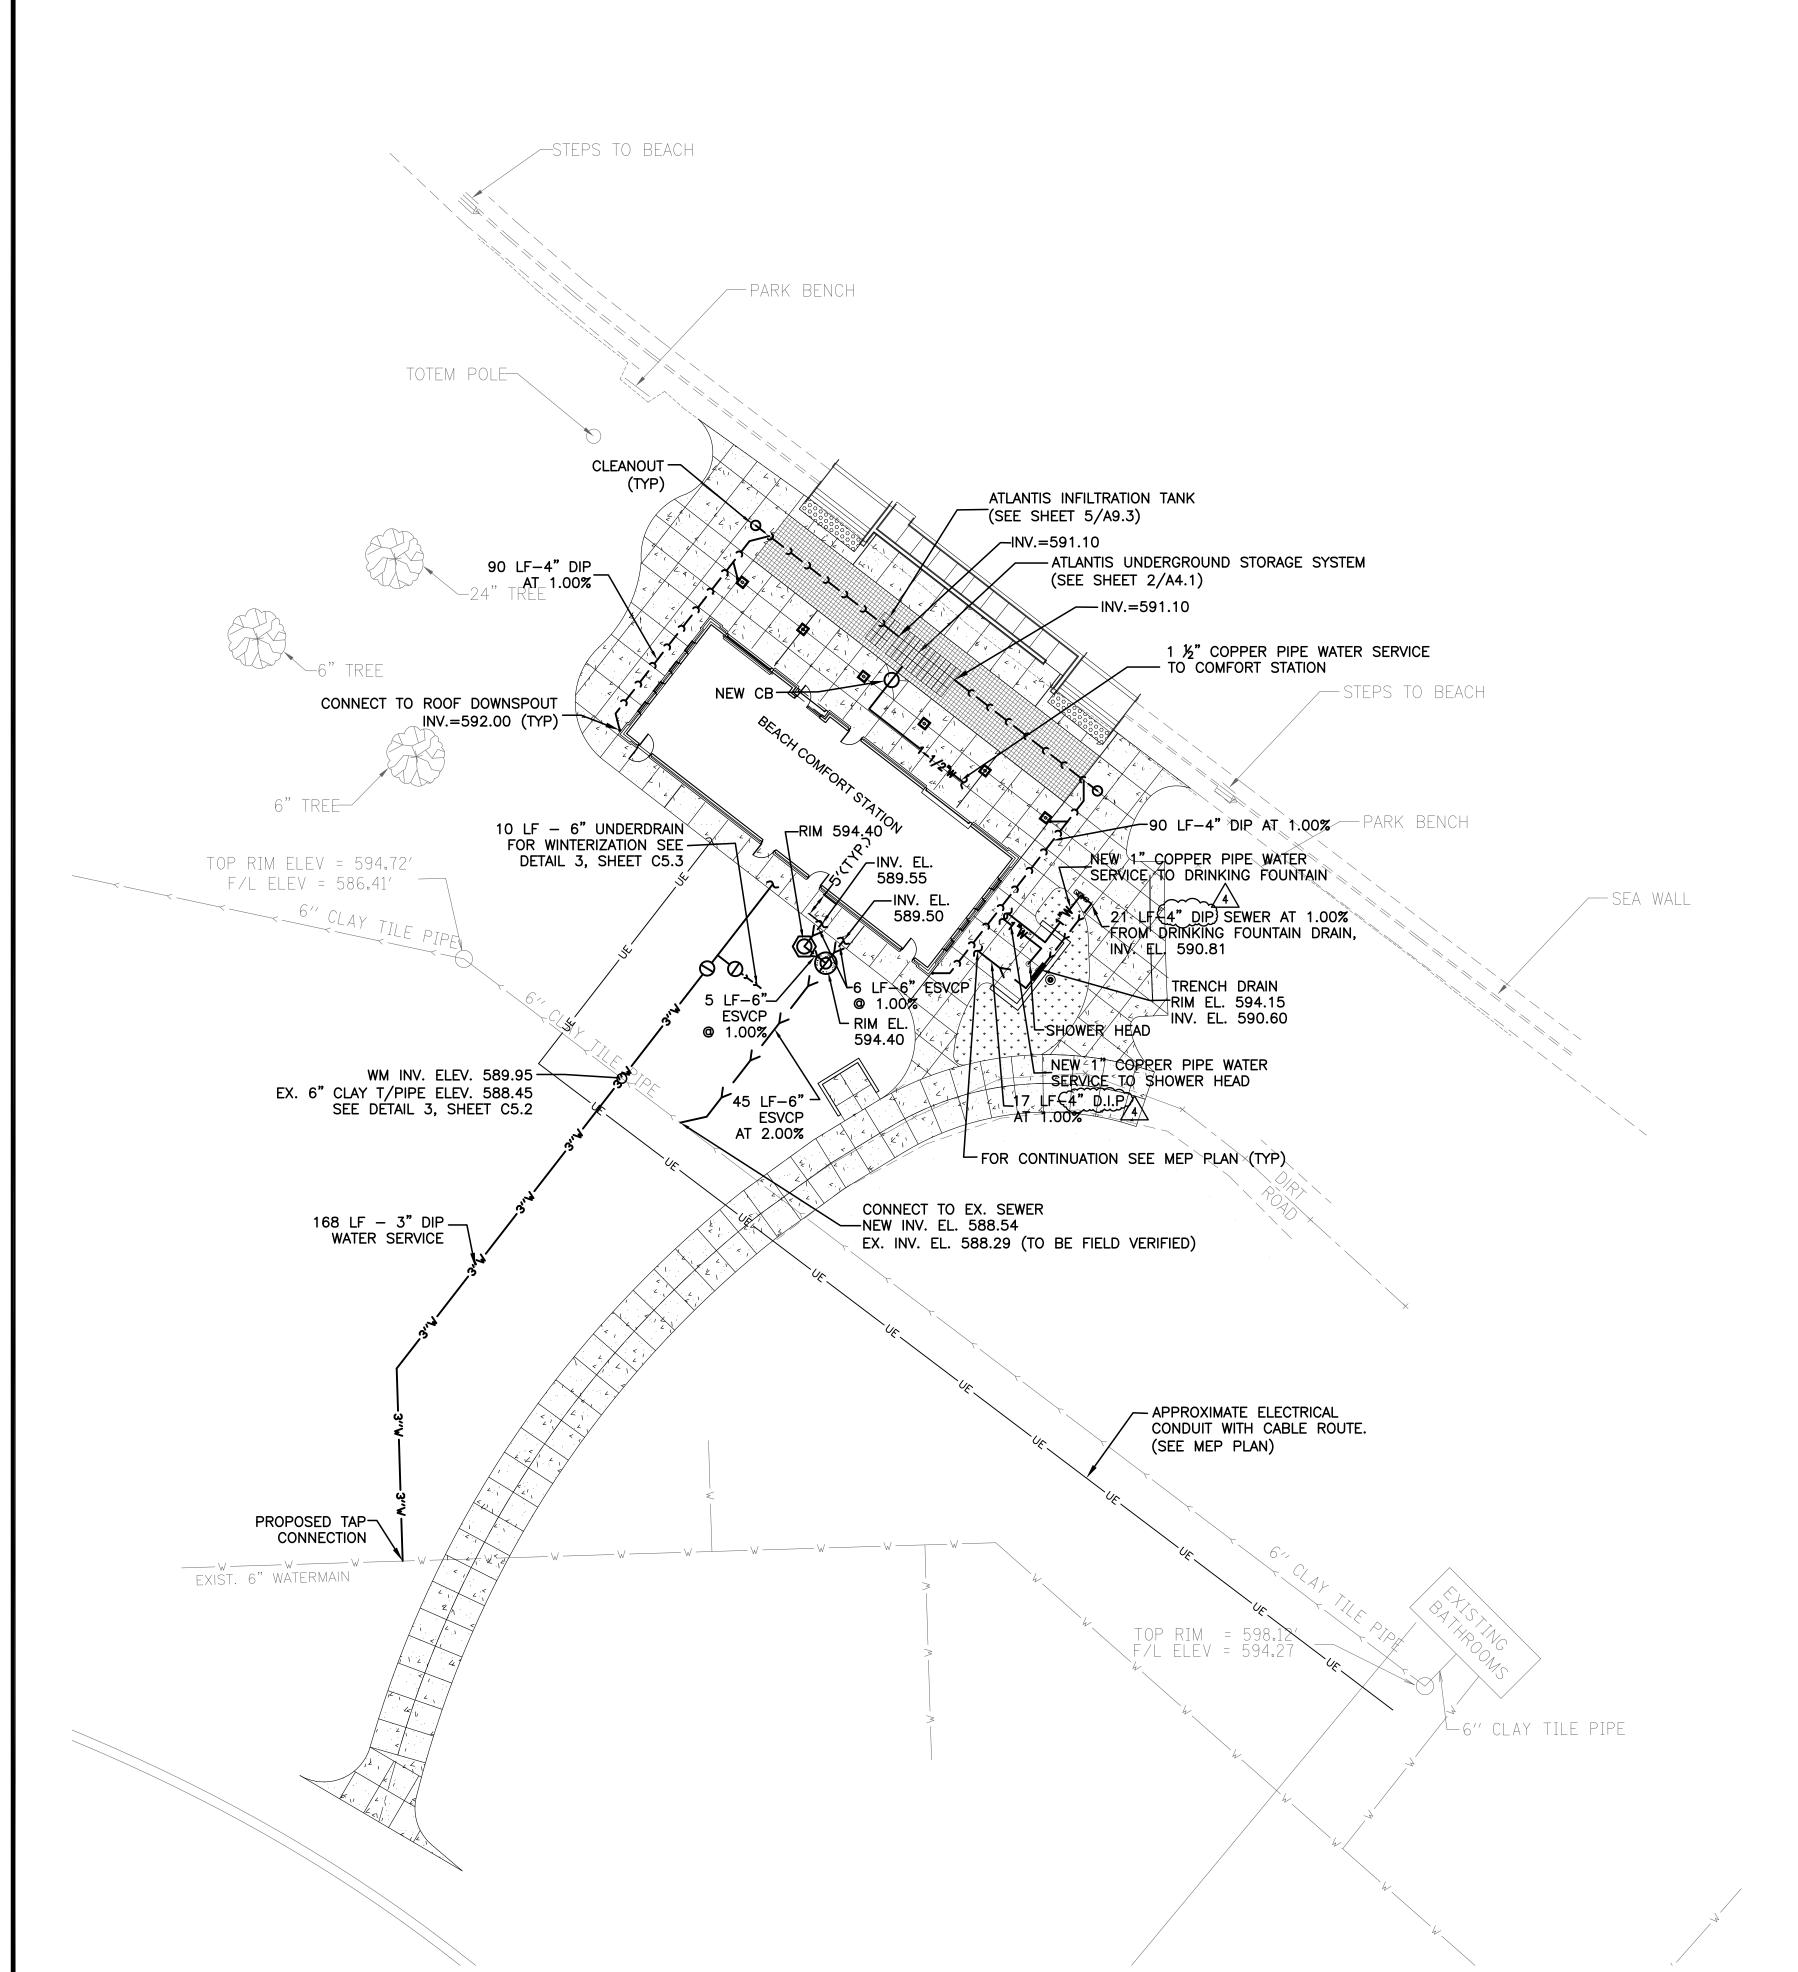

<u>NOTES</u>

- 1. PREVENT ANY DISTURBANCE OF EXISTING TREES, PROTECT EXISTING TREES TO REMAIN IN PLACE AGAINST UNNECESSARY CUTTING, BREAKING OR SKINNING OF ROOTS, BRUISING BARK, SMOTHERING TREES BY STOCKPILING EXCAVATION AND CONSTRUCTION MATERIALS OR PARKING VEHICLES WITHIN THE DRIP LINE IS PROHIBITED. IN CASE OF DAMAGE TO THE EXISTING TREES TO REMAIN, THE CONTRACTOR SHALL REPLACE THE DAMAGED TREE WITH THE SAME SPECIES ON AN INCH FOR INCH BASIS WITHOUT ANY COST TO THE OWNER.
- 2. ADJUST ALL UTILITY STRUCTURES TO MEET FINISH GRADE UNLESS NOTED OTHERWISE.
- 3. SEE M.E.P PLANS BY PRIMERA FOR WATER AND SEWER CONNECTIONS FROM BUILDING TO NEW UTILITIES.
- 4. THE CONTRACTOR SHALL PROTECT SEWER & OTHER UTILITIES AFTER INSTALLATION.
- 5. ALL PIPE LENGTHS ARE CALCULATED FROM CENTER TO CENTER OF STRUCTURE OR PIPE AND ADJUSTED TO FULL FOOT.
- 6. COORDINATES FOR ALL STRUCTURES REFER TO THE CENTER OF STRUCTURE.
- 7. THE CONTRACTOR SHALL PREPARE AS-BUILT PLANS INCLUDING ALL THE NEW UNDERGROUND UTILITIES/FACILITIES AND THE EXISTING UNDERGROUND UTILITIES/FACILITIES TO REMAIN. AS-BUILT PLANS MUST BE SUBMITTED SOON AFTER WORK COMPLETION. FINAL PAYMENT SHALL NOT BE MADE TO THE CONTRACTOR UNTIL THE OWNER ACKNOWLEDGES RECEIPT OF AS-BUILT PLANS.
- 8. SEE M.E.P PLANS BY PRIMERA FOR UNDERGROUND ELECTRIC CONNECTION, AND AT&T ROUTE.

LEGEND

UNDERGROUND ELECTRIC
WATER SERVICE
UNDERDRAIN
STORM SEWER
SANITARY LINE
EXISTING SANITARY LINE
EXISTING WATER LINE
MANHOLE, DETAIL 2, SHEET C5.2
GREASE BASIN, DETAIL 1, SHEET C5.
CATCH BASIN
WATER VALVE BOX, DETAIL 6, SHEET


STRUCTURE	COORDINATE	INVERT ELEVATION
NEW GREASE BASIN	N 1938253.18 E 1169244.17	INV. EL. (NE,SE) 589.49
NEW MANHOLE	N 1938249.69 E 1169248.66	INV. EL. (NW,SW,NE) 589.44
NEW CATCH BASIN (CB) W/CLOSED LID	N 1938308.69 E 1169262.36	SEE SHEET 2/A4.1

CLEANOUT, DETAIL 5, SHEET C5.1



C5.2

GRAPHIC SCALE

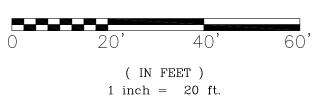



541 NORTH FAIRBANKS CHICAGO, IL 60611

F: 312.432.4184

MULLER+MULLER **a**rchit**e**cts 700 N SANGAMON T: 312.432.4180

CHICAGO, IL 60622 © 2005, Muller & Muller, Ltd.

Muller & Muller, Ltd. expressly reserves its common law copyright and other property rights in these plans. These plans are not to be reproduced, changed or copied in any form or manner whatsoever, nor are they to be assigned to any third party, without firstobtaining the expressed written consent of Muller & Muller, P.C., Ltd.



| INFRASTRUCTURE ENGINEERING | INCORPORATED 33 West Monroe | Suite 1540 | Chicago, IL 60603

P 312.425.9560 | F 312.425.9564 | www.infrastructure-eng.com

6 10.27.2009 ISSUED FOR ADDENDUM #4 5 | 10.20.2009 | ISSUED FOR ADDENDUM #1

4 9.25.2009 ISSUED FOR BID 3 9.21.2009 ISSUED FOR PERMIT/95% DESIGN

2 | 9.04.2009 | ISSUED FOR 90% DESIGN 1 | 3.31.2009 | ISSUED FOR 30% DESIGN


PROJECT

OSTERMAN BEACH COMFORT STATION CHICAGO, IL


SHEET TITLE

UTILITY PLAN


DRAWN: RP SHEET NO. CHECKED: HG C4.1 APPROVED: JOB NO. 09.01.08

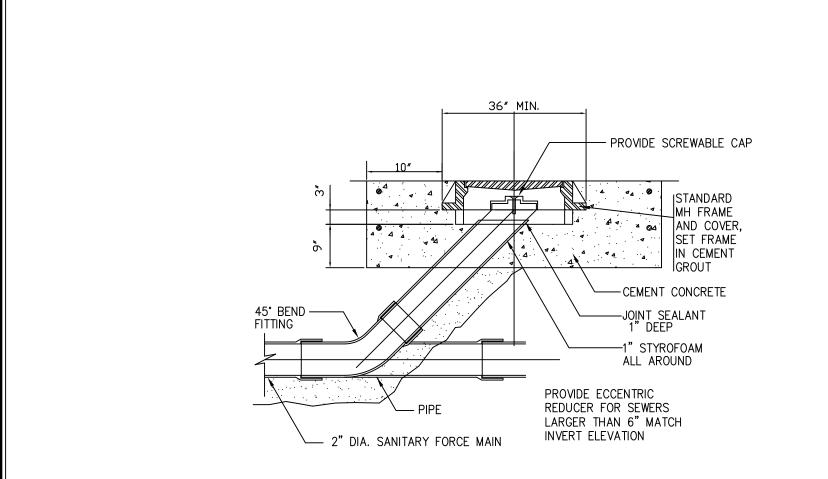


1 CLEANOUT DETAIL FOR FORCE MAIN
NOT TO SCALE

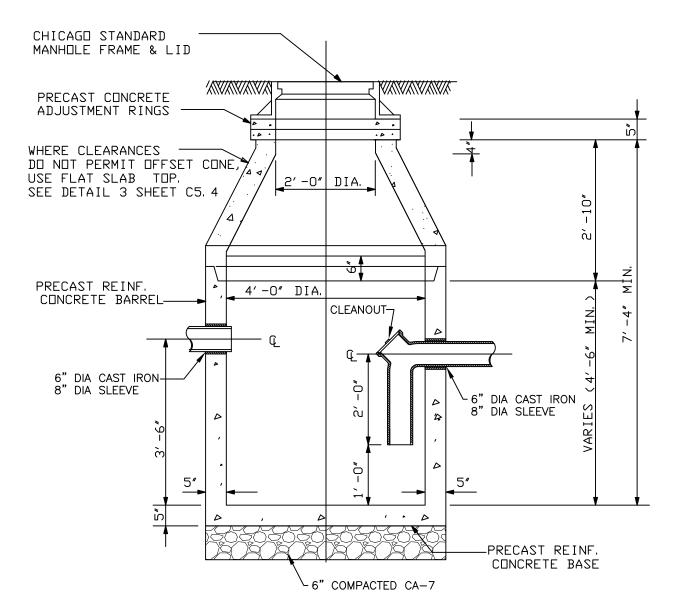

PRECAST GREASE BASIN NOT TO SCALE

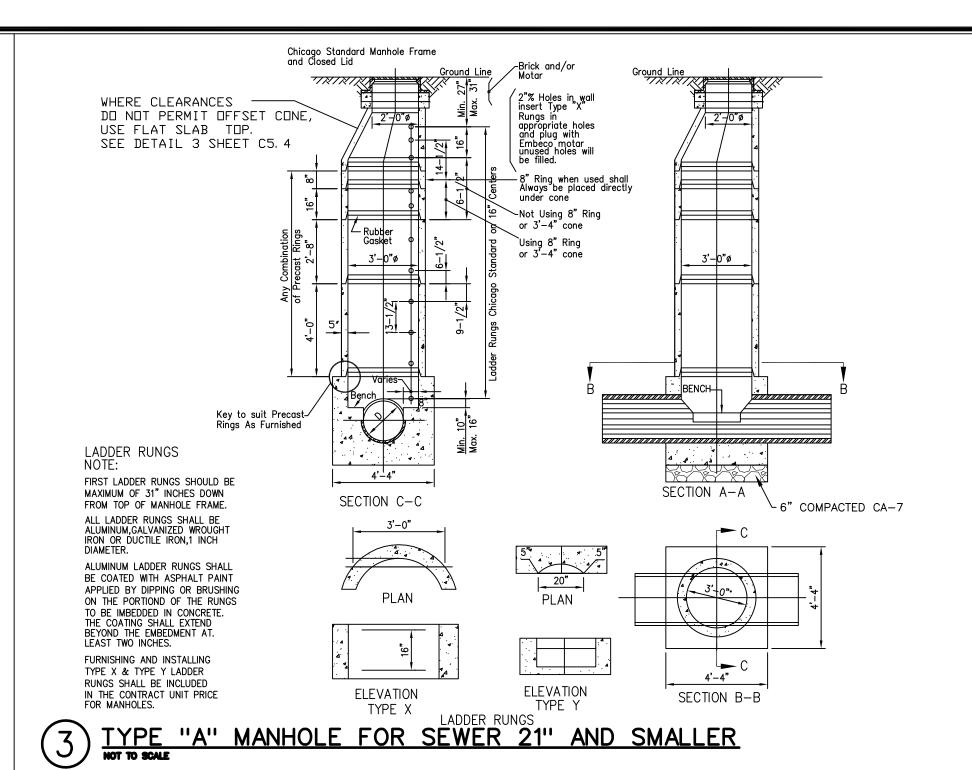

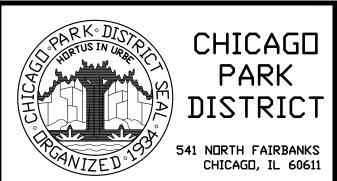

MULLER+MULLER

700 N SANGAMON T 312 432 4180


CHICAGO, IL 60622 F: 312.432.4184


© 2005, Muller & Muller, Ltd.


Muller & Muller, Ltd. expressly reserves its common law copyright and other property rights in these plans. These plans are not to be reproduced, changed or copied in any form or manner whatsoever, nor are they to be assigned to any third party, without firstobtaining the expressed written consent of Muller & Muller, P.C., Ltd.


> | INFRASTRUCTURE ENGINEERING | INCORPORATE

> > 33 West Monroe | Suite 1540 | Chicago, IL 60603 P 312.425.9560 | F 312.425.9564 | www.infrastructure-eng.com

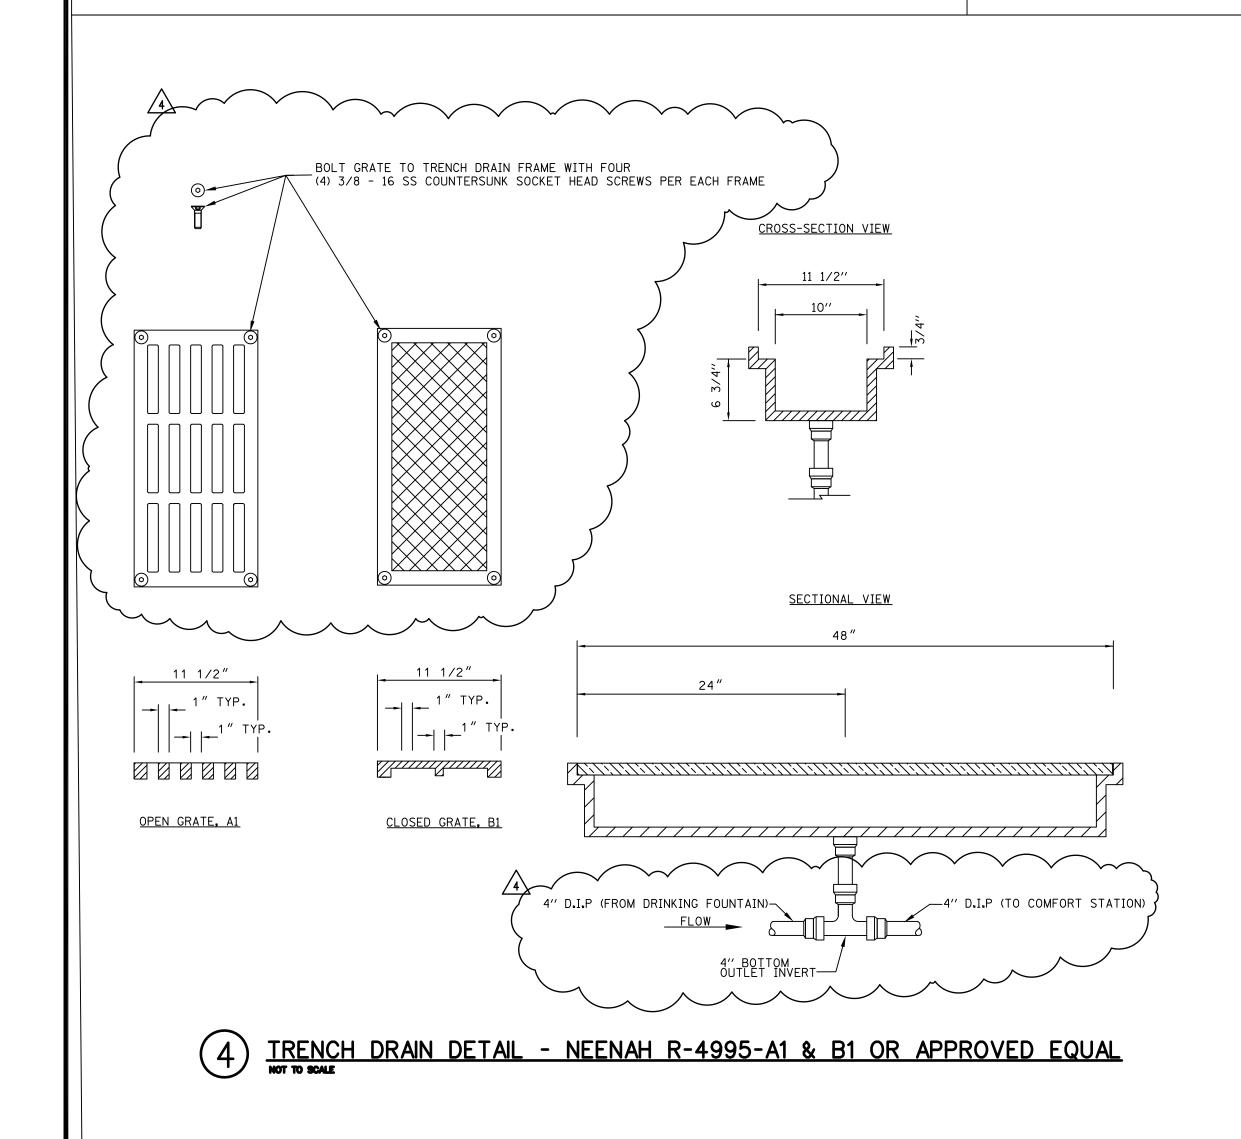

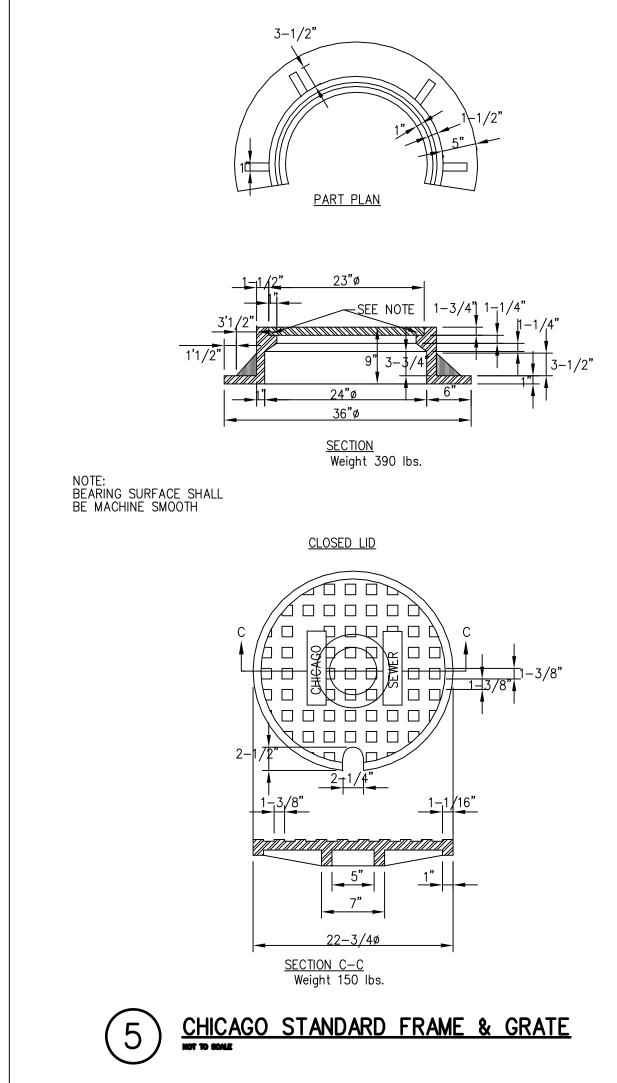

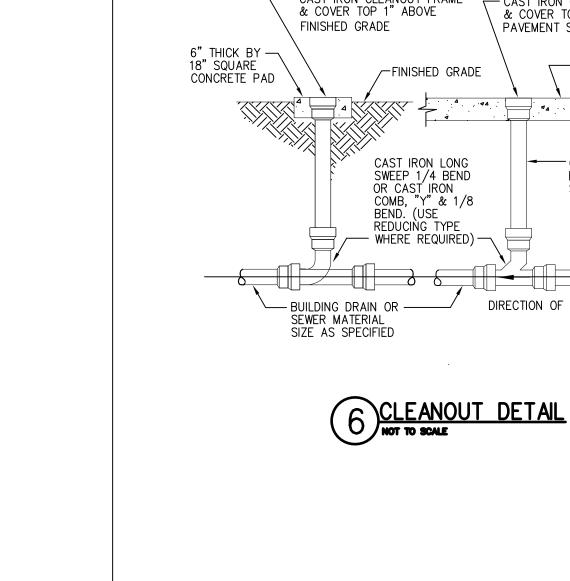

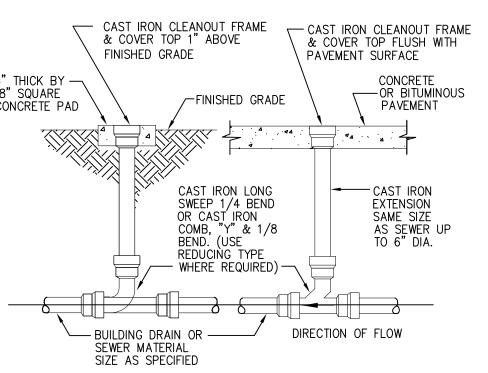

10.27.2009 ISSUED FOR ADDENDUM #4 6 | 10.21.2009 | ISSUED FOR ADDENDUM #2

_		
5	10.20.2009	ISSUED FOR ADDENDUM #1
4	9.25.2009	ISSUED FOR BID
3	9.21.2009	ISSUED FOR PERMIT/95% DESIG
2	9.04.2009	ISSUED FOR 90% DESIGN
1	3.31.2009	ISSUED FOR 30% DESIGN


PROJECT


40TH STREET COMFORT STATION CHICAGO, IL


SHEET TITLE

CIVIL DETAILS

DRAWN: RP	SHEET NO.
CHECKED: HG	050
APPROVED:	C5.2
JOB NO. 09.01.08	

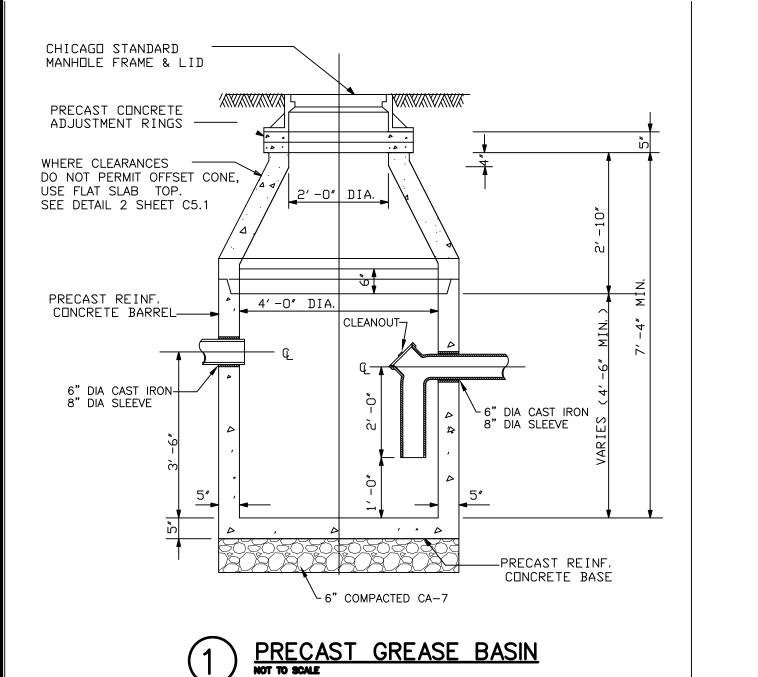

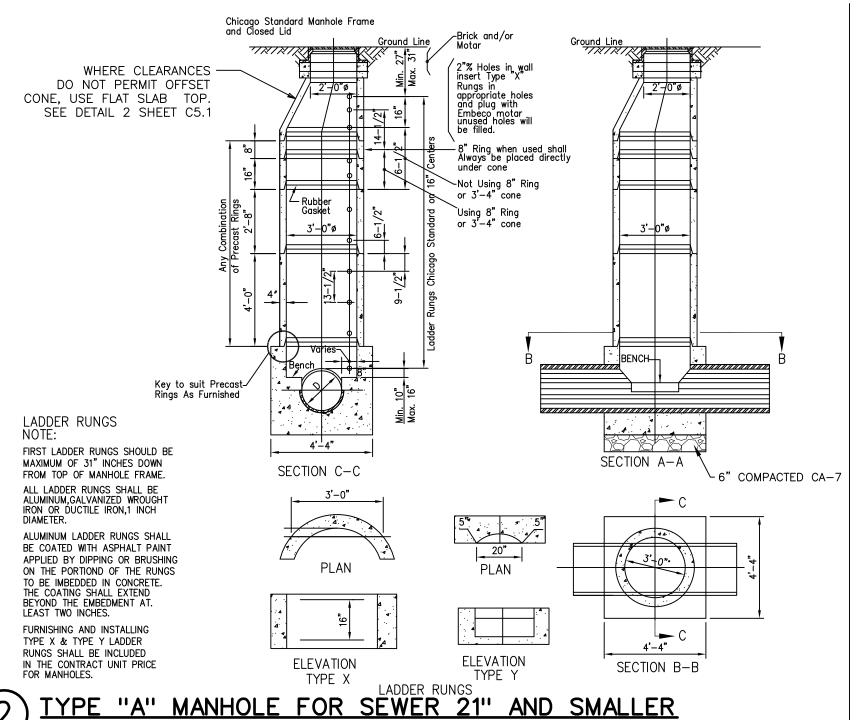


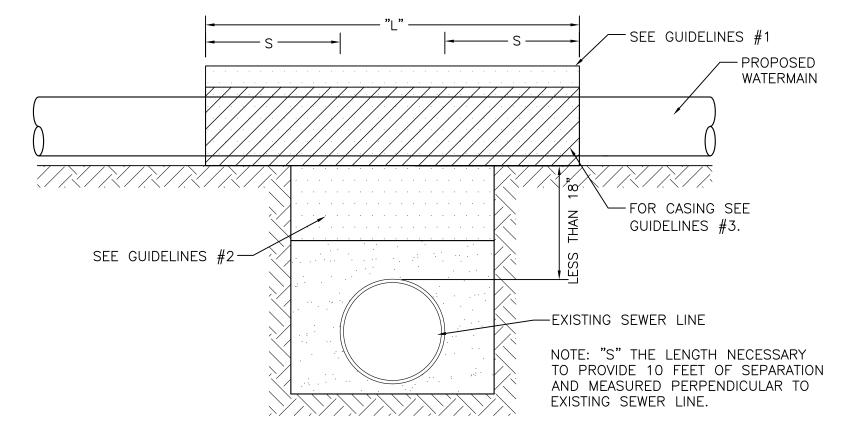



7 PROPOSED WATER MAIN ABOVE EXISTING SEWER WITH LESS THAN 18" MINIMUM VERTICAL SEPARATION (NOT TO SCALE)

GUIDELINES

- 1. OMIT SELECT GRANULAR EMBEDMENT AND GRANULAR BACKFILL TO ONE (1) FOOT OVER TOP OF SEWER AND USE SELECT EXCAVATED MATERIAL (CLASS IV) AND COMPACT THE LENGTH OF "L".
- 2. IF SELECT GRANULAR BACKFILL EXISTS, REMOVE WITHIN WIDTH OF EXISTING SEWER LINE TRENCH AND REPLACE WITH SELECT EXCAVATED MATERIAL (CLASS IV) AND COMPACT.
- 3. USE "L" FEET OF WATER MAIN MATERIAL FOR CASING OF PROPOSED WATER MAIN AND SEAL ENDS OF CASING.
- 4. POINT LOADS SHALL NOT BE ALLOWED BETWEEN WATER MAIN CASING AND SEWER.

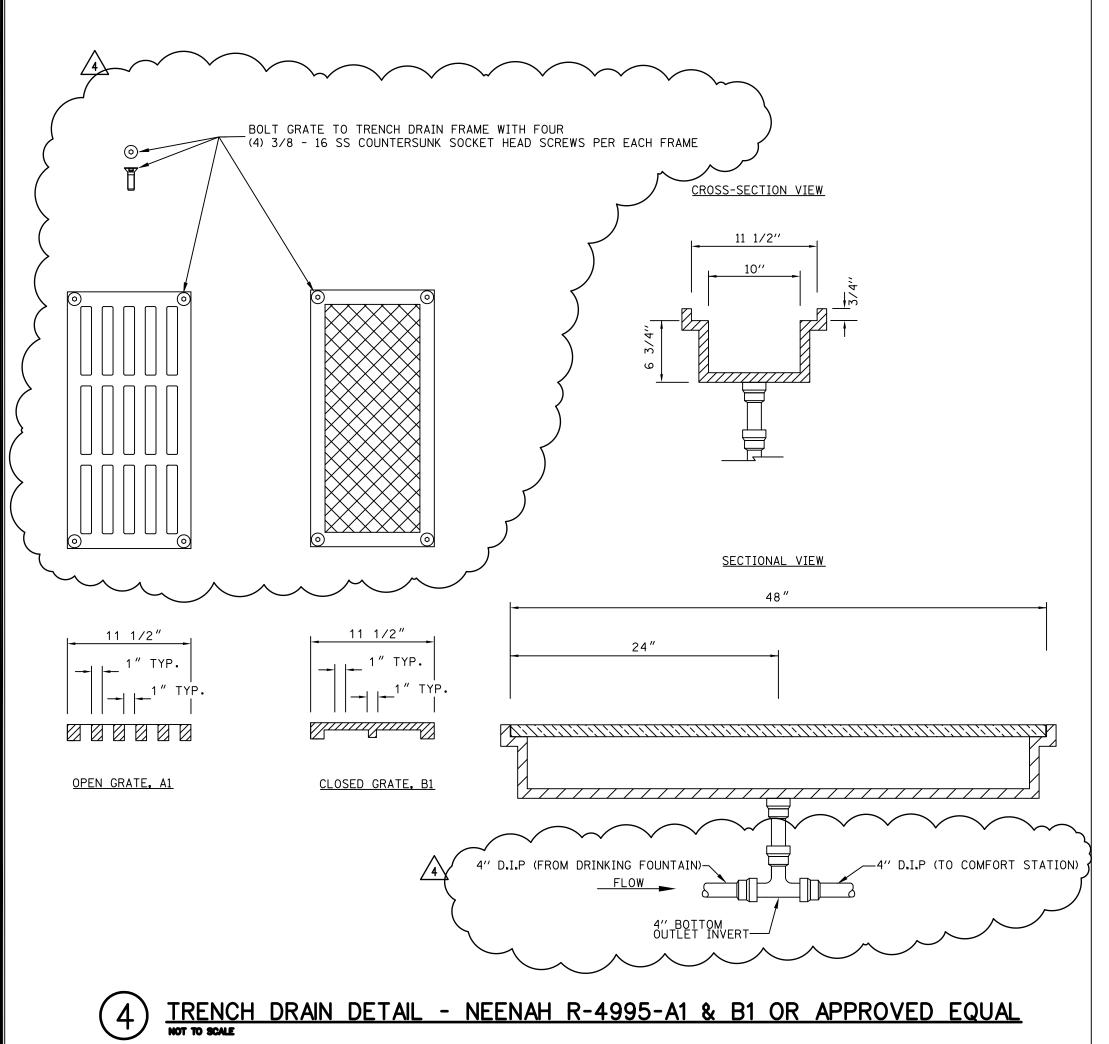

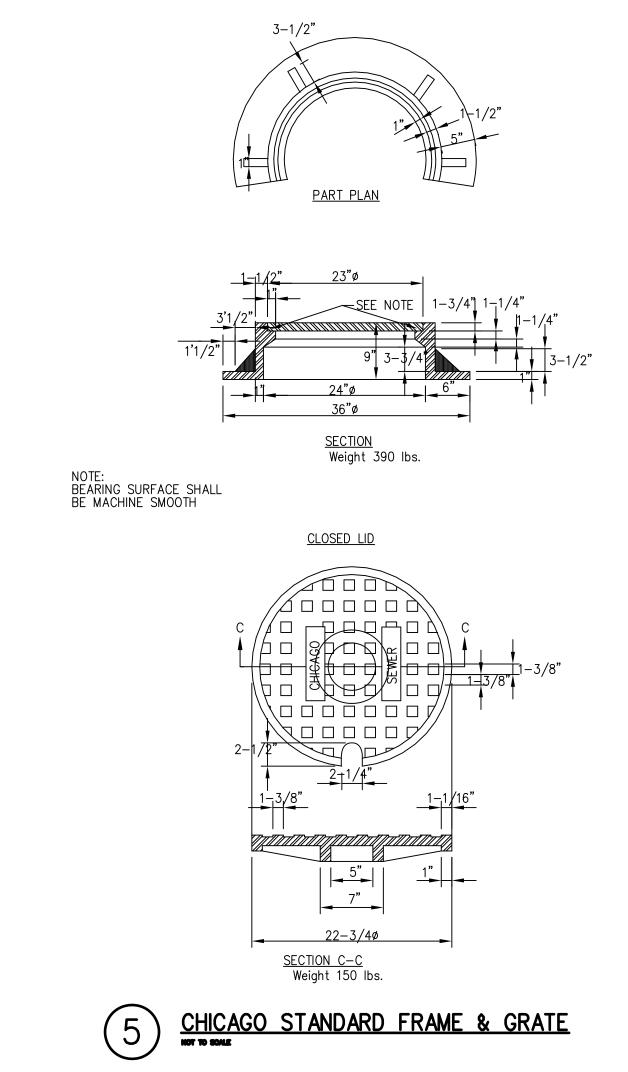

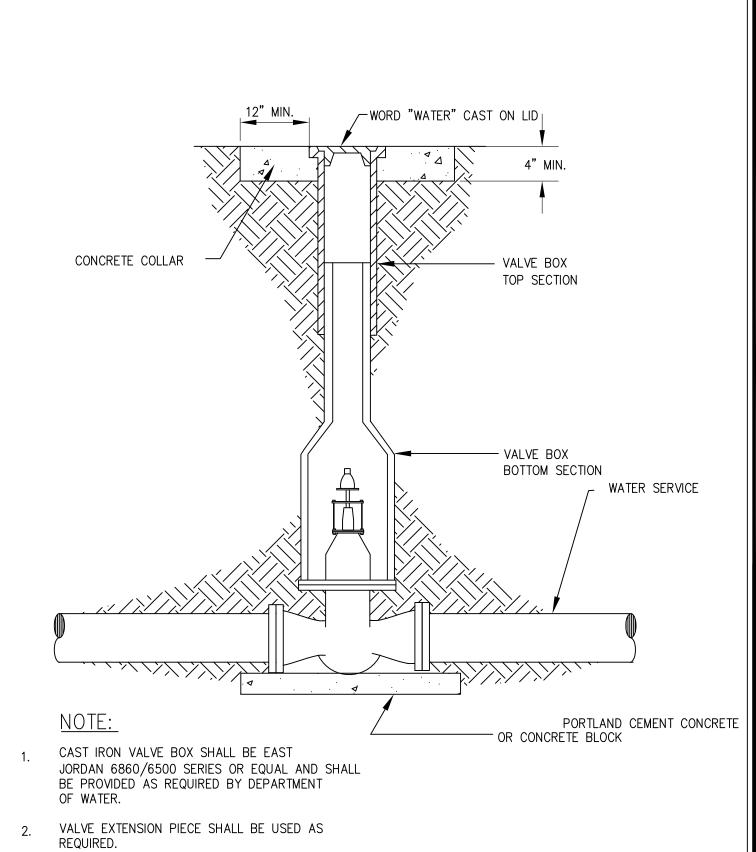

6 BUFFALO VALVE BOX

6 10.27.2009 ISSUED FOR ADDENDUM #4
5 10.20.2009 ISSUED FOR ADDENDUM #1
4 9.25.2009 ISSUED FOR BID
3 9.21.2009 ISSUED FOR PERMIT/95% DESIGN
2 9.04.2009 ISSUED FOR 90% DESIGN
1 3.31.2009 ISSUED FOR 30% DESIGN
PROJECT

CHICAGO

PARK

DISTRICT

541 NORTH FAIRBANKS CHICAGO, IL 60611

architects

T: 312.432.4180

F: 312.432.4184

MULLER+MULLER

Muller & Muller, Ltd. expressly reserves its common law

plans are not to be reproduced, changed or copied in

any form or manner whatsoever, nor are they to be

assigned to any third party, without firstobtaining the

expressed written consent of Muller & Muller, P.C., Ltd.

INFRASTRUCTURE
ENGINEERING | INCORPORATED
33 West Monroe | Suite 1540 | Chicago, IL 60603

P 312.425.9560 | F 312.425.9564 | www.infrastructure-eng.com

copyright and other property rights in these plans. These

700 N SANGAMON

CHICAGO, IL 60622

© 2005, Muller & Muller, Ltd.

OSTERMAN BEACH COMFORT STATION CHICAGO, IL

SHEET TITLE

CIVIL DETAILS

DRAWN: RP	SHEET NO.
CHECKED: HG	05.0
APPROVED:	C5.2
JOB NO. 09.01.08	

PIPE MATERIALS SCHEDULE

BUILDING DRAINAGE & VENT PIPING. INDOOR ABOVE & BELOW FLOOR (SAN. DWV):

- SERVICE CLASS HUB & SPIGOT CAST IRON SOIL PIPE & FITTINGS WITH LEAD & OAKUM CAULKED JOINTS CONFORMING TO ASTM A74; SUSPENDED.
- SERVICE CLASS HUB & SPIGOT CAST IRON SOIL PIPE & FITTINGS WITH GASKETED JOINTS; UNDERGROUND. GALVANIZED STEEL PIPE & FITTINGS CONFORMING TO ASTM A 53. 4. COPPER/COPPER ALLOY PIPE & FITTINGS CONFORMING TO ASTM B 42 & ASTM B 302. COPPER/COPPER ALLOY TUBING & FITTINGS (TYPE M) CONFORMING TO ASTM B 75, ASTM B 88, ASTM B 251.

DOMESTIC WATER DISTRIBUTION PIPING (CW, HW, HWR):

1. ABOVE GROUND: COPPER/COPPER ALLOY PIPE & FITTINGS CONFORMING TO ASTM B 42 & ASTM B 302. COPPER/COPPER ALLOY TUBING & FITTINGS (TYPE L) CONFORMING TO ASTM B 88. LEAD FREE SOLDER.

1. APOLLO BALL VALVES, FULLPORT, ALL SIZES.

INSULATION:

1. 1" THICK FIBERGLASS WITH ALL SERVICE JACKET.

PLUMBI	NG FIX	TURE F					
				H-IN S	CHE	DULE	
AAP	Œ	5	AIR CHAMBER		INLET TO STOP		REMARKS
=	WAS	VĒ	CW	МΗ	CW	МН	
3"	4"	2"	11/4"	-	1"	_	
1½"	2"	1½"	3⁄4"	_	3/4"	_	
11/4"	2"	1½"	3⁄4"	3/4"	1/2"	1/2"	
2"	2"	1½"	3/4"	3⁄4"	1/2"	1/2"	
1½"	2"	1½"	3/4"	3⁄4"	1/2"	½"	
2"	2"	1½"	3/4"	3⁄4"	1/2"	½"	
4"	4"	2"	-	_	-	_	
	1½" 1¼" 2" 1½" 2"	3" 4" 1½" 2" 1¼" 2" 2" 2" 1½" 2"	3" 4" 2" 1½" 2" 1½" 1¼" 2" 1½" 2" 1½" 2" 1½" 2" 1½" 1½" 2" 1½"	ABY BAY 3" 4" 2" 1½" 1½" 2" 1½" ¾" 1½" 2" 1½" ¾" 2" 2" 1½" ¾" 1½" 2" 1½" ¾" 2" 2" 1½" ¾" 2" 1½" ¾"	日本	日本	日本

	DRAIN SCHEDULE											
TAG.	TYPE	MFGR.	MODEL NO.	LOCATION	MATERIAL	NOTES/OPTIONS						
FD-1	FLOOR DRAIN	SMITH	2010-A-NB	FINISHED FLOOR	CAST IRON	WITH ROUND TOP, VANDAL PROOF GRATE & DEEP SEAL TRAP						
FD-2	MECH. ROOM FLOOR DRAIN	SMITH	2010-A-F38	FINISHED FLOOR	CAST IRON	CAST IRON WITH RECESSED GRATE & DEEP SEAL TRAP						
HD-1	HUB DRAIN	WATTS	FD-100-DD	FINISHED FLOOR	CAST IRON	WITH DEEP SEAL TRAP.						

	SPECIALTY EQUIPMENT SCHEDULE										
TAG.	TYPE	MFGR.	MODEL NO.	NOTES/OPTIONS							
TMV-1	POINT OF USE MIXING VALVE	WATTS	USG-B	WITH 3/8" INLET & OUTLETS, MEETS ASSE 1016. PROVIDE AT ALL LAV-1 OUTLET TEMPERATURE: 105'F							
HB-1	EXPOSED HOSE BIBB	CHICAGO FAUCET	387-E27CP	WITH INTEGRAL VACUUM BREAKER. INCLUDE TESTABLE DOUBLE CHECK VALVE ON WATER SUPPLY.							
NFSC-1	EXTERIOR HOSE CONNECTION	JR SMITH	5509 QT	POLISHED BRONZE BOX WITH HOSE CONNECTION WITH VACUUM BREAKER. INCLUDE TESTABLE DOUBLE CHECK VALVE IN WALL BOX ON WATER SUPPLY.							
DCVA-1	DOUBLE CHECK VALVE ASSEMBLY	WATTS	SERIES 007	ASSE 1015 RATED. STAINLESS STEEL CORROSION RESISTANT CONSTRUCTION. INSTALL IN WALL WITH ACCESS PANEL AS REQUIRED. PROVIDE AT HB-1 AND NFSC-1 AS REQUIRED PER PLANS, EQUIPMENT SCHEDULES, AND DETAILS.							
DCVA-2	DUAL CHECK VALVE ASSEMBLY	WATTS	SERIES 7	ASSE 1024 RATED. 3/8" CONNECTION. BRASS BODY CONSTRUCTION. PROVIDE AT ALL ICE MAKER.							
RPZ-1	REDUCED PRESSURE ZONE BACKFLOW PREVENTER	WATTS	SERIES 009	ASSE 1013 RATED. FIELD TESTABLE. BRONZE BODY. PROVIDE DRAIN TO FLOOR DRAIN WITH APPROVED AIR GAP. WITH STRAINER. PROVIDE PER DETAILS, SCHEDULES, AND PLANS.							

	WATER HEATER SCHEDULE												
				DIMEN	ISIONS	ELEC	TRICAL INFORMA	TION	INPUT	DECOMEDY DATE	_		
TAG	QTY.	MANUFACTURER & MODEL No.	STORAGE CAPACITY	DIAMETER INCHES	HEIGHT INCHES	KW	V/PHASE/HZ	AMPS	RATING (BTU/HR)	RECOVERY RATE (100°F RISE)	CW CONN.	HW CONN.	REMARKS
WH-1	1	A.O.SMITH #DSE-120	120 GAL.	2'-6"	5'-5"	24	208/3/60	66.6		98 GPH	1-1/4"	1-1/4"	ROUTE PIPE INDIRECTLY TO FLOOR DRAIN
WH-2	1	A.O SMITH #DEL-20	20 GAL.	22"	31"	5.0	208/3/60	20.5		20 GPH	3/4"		ROUTE PIPE INDIRECTLY FROM DRAIN PAN TO MB-1
WH-3	1	A.O SMITH #DEL-50	50 GAL.	26"	32"	12.0	208/3/60	57.7		61 GPH	3/4"		ROUTE PIPE INDIRECTLY FROM DRAIN PAN TO FLOOR DRAIN IN MECHANICAL ROO

MOUNT WH-2 OVERHEAD.

MOUNT WH-3 ABOVE CEILING.
PROVIDE WH-1 WITH AMTROL ST-12 EXPANSION TANK. PROVIDE WH-2 & WH-3 WITH AMTROL ST-5 EXPANSION TANK.

PLUMBING NOTES

- 1. THE PLUMBING CONTRACTOR SHALL BE RESPONSIBLE FOR ALL PERMITS AND FEES FOR HIS WORK.
- 2. REFER TO ARCHITECTURAL DRAWINGS FOR ALL FIXTURE LOCATIONS.
- 3. PLUMBING CONTRACTOR SHALL BE RESPONSIBLE FOR LOCATING AND SIZING ALL WATER HAMMER ARRESTERS PER MANUFACTURER'S RECOMMENDATIONS. REFER TO "PLUMBING ACCESSORIES" SECTION OF THE SPECIFICAITONS.
- 4. THE MINIMUM SIZE OF ALL VENT PIPING SHALL BE 1/2 THE SIZE ASSOCIATED DRAIN, BUT NOT LESS THAN 1-1/2".
- 5. CONTRACTOR TO PROVIDE DEEP SEAL TRAPS FILLED WITH MINERAL OIL ON ALL FLOOR DRAINS LOCATED IN AREAS SUSCEPTIBLE TO DRYING OUT, MECHANICAL ROOMS.
- 6. CONTRACTOR SHALL PROVIDE DRAIN VALVES AT THE BOTTOM OF ALL RISERS AND AT THE END OF EACH HORIZONTAL RUN OF WATER PIPING. DRAIN VALVE SHALL BE INCLUDED WITH A 3/4" THREADED CONNECTION FOR WINTER DRAINAGE.
- 7. HORIZONTAL DRAINS WITHIN THE BUILDING SHALL BE PROVIDED WITH CLEANOUTS LOCATED NOT MORE THAN 50' APART FOR DRAINS 4"
- 8. INSTALL DRAIN VALVES AT BASE OF EACH WATER RISER, AT LOW POINTS IN HORIZONTAL PIPING, AND WHERE REQUIRED TO DRAIN WATER PIPING. DRAIN VALVES ARE SPECIFIED IN DIVISION 15 SECTION "DOMESTIC WATER PIPING SPECIALTIES." PROVIDE ACCESS PANELS AS REQUIRED.

SUSPENDED PIPING SYSTEMS

---- - DOMESTIC COLD WATER PIPE ----- DOMESTIC HOT WATER PIPE NPW—NON-POTABLE WATER SANITARY, SOIL OR WASTE PIPE — — — — — SANITARY VENT PIPE

RISER DIAGRAM SYMBOLS

FIXTURE

NAME

QTY

LOCATION

PLBG

SYMBOL

<u>WC-1</u>

<u>WC-2</u>

<u>UR-1</u>

<u>UR-2</u>

<u>LAV-1</u>

<u>LAV-2</u>

<u>SK-1</u>

<u>SK-2</u>

<u>SK-3</u>

<u>SH-1</u>

<u>MB-1</u>

<u>DF-1</u>

<u>0SH-1</u>


TRIPLE BASIN

SHOWER

MOP BASIN

FOUNTAIN

OUTDOOR

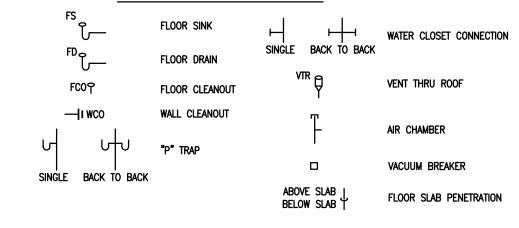

AD ACCESS DOOR AFF ABOVE FINISHED FLOOR AP ACCESS PANEL ARCH ARCHITECTURAL BOP BOTTOM OF PIPE BALV BALANCING VALVE BV BALL VALVE CAST IRON CL CENTER LINE CLG CEILING

- CLEANOUT CON CONCRETE CHECK VALVE CW COLD WATER DFU DRAIN FIXTURE UNITS DIAMETER
- DOWN DWG DRAWING DWH DOMESTIC WATER HEATER EACH EA ELEVATION
- EWC ELECTRIC WATER COOLER DEGREES FAHRENHEIT FLEX FLEXIBLE

FF FINISHED FLOOR

<u>SYMBOLS</u> ELBOW DOWN **—**∍ \multimap ELBOW UP **—**⊃0 FIXTURE TRAP SWING CHECK VALVE ⊣Ō⊢ PIPE CAP **-**∃ **--**1∙ CO PLUG CLEANOUT

—l∙ wco WALL CLEANOUT —⊗ FC0 FLOOR CLEANOUT ROOF DRAIN

REDUCED PRESSURE BACKFLOW PREVENTOR $\rightarrow >> \vdash$ FIXTURE TRANSFORMER

FIXTURE

FLOOR MOUNTED

STAINLESS STEEL

SHOWER

FLOOR MOUNTED

PRECAST TERRAZZO

STAINLESS STEEL

PEDESTAL STAINLESS

CONCESSION

REST ROOM

JANITOR

OUTDOORS

REFER TO

DOCUMENTS

MFR/MODEL

RNSF8354

SYMMONS / S-4701-1.5

FIAT / TSB 3000

SERIES

HAWS / 3500D

BRADLEY /

COL-6B-SV-ST

PLUMBING FIXTURE SCHEDULE

VALVE/FAUCET/TRIM

MFR/MODEL

ABBREVIATIONS

FLR FLOOR PG PRESSURE GAUGE FPM FEET PER MINUTE PSI PER SQUARE INCH ft feet RET RETURN GA GAUGE RM ROOM GCO GRADE CLEANOUT RPM REVOLUTIONS PER MINUTE GV GATE VALVE SF SQUARE FEET GPM GALLONS PER MINUTE HOR HORIZONTAL SS SERVICE SINK HW HOT WATER TH THERMOMETER HWR HOT WATER RECIRCULATING HTR HEATER TMV THERMOSTATIC MIXING VALVE HVAC HEATING, VENTILATION & AIR CONDITIONING TOS TOP OF SLAB HZ HERTZ TYP TYPICAL IN INCHES V VENT VB VACUUM BREAKER

INS INSULATION LAV LAVATORY MFR MANUFACTURER MAX MAXIMUM

MIN MINIMUM MS MOP SINK NC NORMALLY CLOSED NIC NOT IN CONTRACT NO NORMALLY OPEN NPW NON-POTABLE WATER NTS NOT TO SCALE

OD OUTSIDE DIAMETER OFRD OVERFLOW ROOF DRAIN OW OPEN WASTE

SUPPLIES

LOOSE KEY ANGLE

STOPS

INTEGRAL STOPS

WITH VALVE

SUPPLIES WITH

INTEGRAL STOPS. ALL

CONCEALED PIPING.

LINE VALVE

SUPPLIES WITH

INTEGRAL STOPS.

REFERENCE SYMBOLS

ADDITIONAL REQUIREMENTS & NOTES

WITH ELKAY LK18B STAINLESS STEEL BODY AND GRID STRAINER.

ADJUST STOP SCREW FOR OUTLET TEMP MAX: 105°F

WITH CHICAGO FAUCET 390-PRJKCP LEVER HANDLES.

WITH FD-1 WITH SQUARE GRATE.

WITH VACUUM BREAKER AT 7'-6" AFF.

SIZE PER ARCHITECTURAL DOCUMENTS.

SHOWERHEAD HEIGHT TO BE AT 6'-0".

BARRIER FREE BI-LEVEL WITH PET FOUNTAIN.

FOUNTAIN SHALL BE BLACK COLOR FINISH.

WITH 1453 FLAT STEEL STRAINER.

VEL VELOCITY

VTR VENT THROUGH ROOF

WHA WATER HAMMER ARRESTOR

WC WATER CLOSET

EQUIPMENT IDENTIFICATION

TYPE TYPE VALL HUNG ELONGATED STANDARD RIM HEIGHT. WATER CLOSET 1" ANGLE STOP REST ROOM 140-1.6 ÉS-S WITH OPEN FRONT SEAT LESS COVER. STAINLESS STEEL CONCEALED SENSOR 1.6 GPF WALL HUNG ELONGATED WITH RIM HEIGHT AT 17-1/2" WATER CLOSET 1" ANGLE STOP REST ROOM 140-1.6 ES-S STAINLESS STEEL CONCEALED SENSOR WITH OPEN FRONT SEAT LÉSS COVER. 1.6 GPF WITH RIM HEIGHT AT 17-1/2" WALL HUNG ELONGATED WATER CLOSET 1" ANGLE STOP KOHLER / K-4325 MANUAL EXPOSED CROWN - 111 1.28 GPF REST ROOM VITREOUS CHINA WITH OPEN FRONT SEAT LÉSS COVER. WALL HUNG HARD-WIRED WITH RIM HEIGHT AT 16". 190-1.0-ES-S 3/4" ANGLE STOP URINAL RESTROOM STAINLESS STEEL 1702-W-1 CONCEALED SENSOR WITH WALL CARRIER. 1.0 GPF WITH STANDARD RIM HEIGHT. 3/4" ANGLE STOP 190-1.0-ES-S 1.0 GPF URINAL RESTROOM STAINLESS STEEL 1702-W-1 CONCEALED SENSOR WITH WALL CARRIER. CHICAGO FAUCET WALL HUNG STAINLESS LOOSE KEY ANGLE PUBLIC TOILET ACORN / 333-E2805-WITH GRID STRAINER LAVATORY METERING 1955-1-9-H24-GT 665PSHABCP WITH (2) FAUCETS, (1) FOR HOT & (1) FOR COLD 0.5 GPM CHICAGO FAUCET / 201-AGN2AE3-317CP WALL HUNG VITREOUS LOOSE KEY ANGLE WITH 0.5 GPM AERATOR AND TMV-1 LAVATORY REST ROOM K-2035-4 WRISTBLADES WITH GRID STRAINER 0.5 GPM REFER TO ARCHITECTURAL MODULAR KITCHENETTE UNIT. LOOSE KEY ANGLE LIFEGUARD ROUTE WATER & WASTE PIPING IN PARTIAL HEIGHT WALL TO DWYER UNIT INCLUDED ----OFFICE STOPS DOCUMENTS FULL HEIGHT WALL BETWEEN LIFEGUARD AND CONCESSION. WALL HUNG STAINLESS LOOSE KEY ANGLE GOOSNECK WITH CONCESSION ELKAY / LKB400 WITH ELKAY LKB8 STAINLESS STEEL BODY AND GRID STRAINER. HAND SINK CHSB1716C WRISTBLADES STOPS

LK940AT08L2H

SYMMONS

CHICAGO FAUCET ,

HAWS

BRADLEY

GOOSNECK WITH

WRISTBLADES

PRESSURE BALANCE

LEVER HANDLES AND


VACUUM BREAKER

PUSH BUTTON

PUSH BUTTON

1. PROVIDE TRANSFORMER (SLOAN EL-154) AS INDICATED ON PLANS FOR HARD WIRED WATER CLOSETS AND URINALS.

DAISY CHAIN AS MANY AS (10) WATER CLOSETS AND URINALS \ OFF OF (1) SLOAN EL-154 TRANSFORMER.

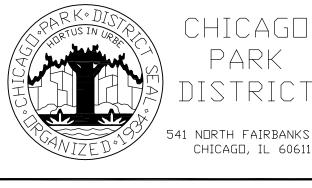

700 N SANGAMON T: 312.432.4180 CHICAGO, IL 60622 F: 312.432.4184

© 2005, Muller & Muller, Ltd.

Muller & Muller, Ltd. expressly reserves its common law copyright and other property rights in these plans. These plans are not to be reproduced, changed or copied in any form or manner whatsoever, nor are they to be assigned to any third party, without firstobtaining the expressed written consent of Muller & Muller, P.C., Ltd.



5	10.27.2009	ISSUED FOR ADDENDUM 4 4
4	9.25.2009	ISSUED FOR BID
3	9.21.2009	ISSUED FOR PERMIT/95% DESIGN
2	9.04.2009	ISSUED FOR 90% DESIGN

3.31.2009 | ISSUED FOR 30% DESIGN **PROJECT**

40TH STREET BEACH COMFORT STATION CHICAGO, IL

SHEET TITLE

PLUMBING GEN. NOTES, **ABBREVIATIONS & SYMB.**

SHEET NO.

DRAWN:	BDT
CHECKED:	MJC
APPROVED:	MJC
JOB NO. 09.01.08	

PIPE MATERIALS SCHEDULE

BUILDING DRAINAGE & VENT PIPING, INDOOR ABOVE & BELOW FLOOR (SAN, DWV):

- SERVICE CLASS HUB & SPIGOT CAST IRON SOIL PIPE & FITTINGS WITH LEAD & OAKUM CAULKED JOINTS CONFORMING TO ASTM A74; SUSPENDED.
- SERVICE CLASS HUB & SPIGOT CAST IRON SOIL PIPE & FITTINGS WITH GASKETED JOINTS; UNDERGROUND. GALVANIZED STEEL PIPE & FITTINGS CONFORMING TO ASTM A 53.
- 4. COPPER/COPPER ALLOY PIPE & FITTINGS CONFORMING TO ASTM B 42 & ASTM B 302. COPPER/COPPER ALLOY TUBING & FITTINGS (TYPE M) CONFORMING TO ASTM B 75, ASTM B 88, ASTM B 251.

DOMESTIC WATER DISTRIBUTION PIPING (CW. HW. HWR):

1. ABOVE GROUND: COPPER/COPPER ALLOY PIPE & FITTINGS CONFORMING TO ASTM B 42 & ASTM B 302. COPPER/COPPER ALLOY TUBING & FITTINGS (TYPE L) CONFORMING TO ASTM B 88. LEAD FREE SOLDER. VALVES:

1. APOLLO BALL VALVES, FULLPORT, ALL SIZES.

INSULATION:

1. 1" THICK FIBERGLASS WITH ALL SERVICE JACKET.

PLUMBING FIXTURE ROUGH-IN SCHEDULE								
FIXTURE TYPE	TRAP	WASTE	VENT	AIR CH	AIR CHAMBER		O STOP	REMARKS
	1L			CW	МН	δ	ЖH	
WATER CLOSET	3"	4"	2"	11/4"	ı	1"	_	
URINAL	1½"	2"	1½"	3/4"	-	3/4"	_	
LAVATORY	1¼"	2"	1½"	3/4"	3⁄4"	1/2"	1/2"	
SHOWER	2"	2"	1½"	3/4"	3/4"	1/2"	1/2"	
SINK	1½"	2"	1½"	3⁄4"	3⁄4"	1/2"	1/2"	
MOP BASIN	2"	2"	1½"	3/4"	3/4"	1/2"	1/2"	
FLOOR DRAIN (FD-1, FD-2)	4"	4"	2"	_	_	_	_	

	DRAIN SCHEDULE										
TAG.	TYPE	MFGR.	MODEL NO.	LOCATION	MATERIAL	NOTES/OPTIONS					
FD-1	FLOOR DRAIN	SMITH	2010-A-NB	FINISHED FLOOR	CAST IRON	WITH ROUND TOP, VANDAL PROOF GRATE & DEEP SEAL TRAP					
FD-2	MECH. ROOM FLOOR DRAIN	SMITH	2010-A-F38	FINISHED FLOOR	CAST IRON	CAST IRON WITH RECESSED GRATE & DEEP SEAL TRAP					
HD-1	HUB DRAIN	WATTS	FD-100-DD	FINISHED FLOOR	CAST IRON	WITH DEEP SEAL TRAP.					

	SPECIALTY EQUIPMENT SCHEDULE									
TAG.	TYPE	MFGR.	MODEL NO.	NOTES/OPTIONS						
TMV-1	POINT OF USE MIXING VALVE	WATTS	USG-B	WITH 3/8" INLET & OUTLETS, MEETS ASSE 1016. PROVIDE AT ALL LAV-1 OUTLET TEMPERATURE: 105°F						
HB-1	EXPOSED HOSE BIBB	CHICAGO FAUCET	387-E27CP	WITH INTEGRAL VACUUM BREAKER. INCLUDE TESTABLE DOUBLE CHECK VALVE ON WATER SUPPLY.						
NFSC-1	EXTERIOR HOSE CONNECTION	JR SMITH	5509 QT	POLISHED BRONZE BOX WITH HOSE CONNECTION WITH VACUUM BREAKER. INCLUDE TESTABLE DOUBLE CHECK VALVE IN WALL BOX ON WATER SUPPLY.						
DCVA-1	DOUBLE CHECK VALVE ASSEMBLY	WATTS	SERIES 007	ASSE 1015 RATED. STAINLESS STEEL CORROSION RESISTANT CONSTRUCTION. INSTALL IN WALL WITH ACCESS PANEL AS REQUIRED. PROVIDE AT HB-1 AND NFSC-1 AS REQUIRED PER PLANS, EQUIPMENT SCHEDULES, AND DETAILS.						
DCVA-2	DUAL CHECK VALVE ASSEMBLY	WATTS	SERIES 7	ASSE 1024 RATED. 3/8" CONNECTION. BRASS BODY CONSTRUCTION. PROVIDE AT ALL ICE MAKER.						
RPZ-1	REDUCED PRESSURE ZONE BACKFLOW PREVENTER	WATTS	SERIES 009	ASSE 1013 RATED. FIELD TESTABLE. BRONZE BODY. PROVIDE DRAIN TO FLOOR DRAIN WITH APPROVED AIR GAP. WITH STRAINER. PROVIDE PER DETAILS, SCHEDULES, AND PLANS.						

	WATER HEATER SCHEDULE												
					ISIONS	S ELECTRICAL INFORMATION			INPUT	DEOOVEDY DATE			
TAG	QTY.	MANUFACTURER & MODEL No.	STORAGE CAPACITY	DIAMETER INCHES	HEIGHT INCHES	KW	V/PHASE/HZ	AMPS	RATING	RECOVERY RATE (100°F RISE)	CW CONN.	HW CONN.	REMARKS
WH-1	1	A.O.SMITH #DSE-120	120 GAL.	2'-6"	5'-5"	24	208/3/60	66.6		98 GPH	1-1/4"	1-1/4"	ROUTE PIPE INDIRECTLY TO FLOOR DRAIN
WH-2	1	A.O SMITH #DEL-20	20 GAL.	22*	31"	5.0	208/3/60	20.5		20 GPH	3/4"	3/4"	ROUTE PIPE INDIRECTLY FROM DRAIN PAN TO MB-1
WH-3	1	A.O SMITH #DEL-50	50 GAL.	26"	32"	12.0	208/3/60	57.7		61 GPH	3/4"	3/4"	ROUTE PIPE INDIRECTLY FROM DRAIN PAN TO FLOOR DRAIN IN MECHANICAL ROOM

NOTES:
1. MOUNT WH-2 OVERHEAD.

MOUNT WH-3 ABOVE CEILING.
PROVIDE WH-1 WITH AMTROL ST-12 EXPANSION TANK. PROVIDE WH-2 & WH-3 WITH AMTROL ST-5 EXPANSION TANK.

PLUMBING NOTES

1. THE PLUMBING CONTRACTOR SHALL BE RESPONSIBLE FOR ALL PERMITS AND FEES FOR HIS WORK.

2. REFER TO ARCHITECTURAL DRAWINGS FOR ALL FIXTURE LOCATIONS.

3. PLUMBING CONTRACTOR SHALL BE RESPONSIBLE FOR LOCATING AND SIZING ALL WATER HAMMER ARRESTERS PER MANUFACTURER'S RECOMMENDATIONS. REFER TO "PLUMBING ACCESSORIES" SECTION OF THE SPECIFICAITONS.

4. THE MINIMUM SIZE OF ALL VENT PIPING SHALL BE 1/2 THE SIZE ASSOCIATED DRAIN, BUT NOT LESS THAN 1-1/2".

5. CONTRACTOR TO PROVIDE DEEP SEAL TRAPS FILLED WITH MINERAL OIL ON ALL FLOOR DRAINS LOCATED IN AREAS SUSCEPTIBLE TO

6. CONTRACTOR SHALL PROVIDE DRAIN VALVES AT THE BOTTOM OF ALL RISERS AND AT THE END OF EACH HORIZONTAL RUN OF WATER PIPING. DRAIN VALVE SHALL BE INCLUDED WITH A 3/4" THREADED CONNECTION FOR WINTER DRAINAGE.

7. HORIZONTAL DRAINS WITHIN THE BUILDING SHALL BE PROVIDED WITH CLEANOUTS LOCATED NOT MORE THAN 50' APART FOR DRAINS 4"

8. INSTALL DRAIN VALVES AT BASE OF EACH WATER RISER, AT LOW POINTS IN HORIZONTAL PIPING, AND WHERE REQUIRED TO DRAIN WATER PIPING. DRAIN VALVES ARE SPECIFIED IN DIVISION 15 SECTION "DOMESTIC WATER PIPING SPECIALTIES." PROVIDE ACCESS PANELS AS REQUIRED.

> SUSPENDED PIPING SYSTEMS ---- - DOMESTIC COLD WATER PIPE ----- DOMESTIC HOT WATER PIPE NPW—NON-POTABLE WATER SANITARY, SOIL OR WASTE PIPE

RISER DIAGRAM SYMBOLS

— — — — — SANITARY VENT PIPE

FLOOR SINK WATER CLOSET CONNECTION SINGLE BACK TO BACK FLOOR DRAIN FC0우 FLOOR CLEANOUT --|ı wco WALL CLEANOUT AIR CHAMBER VACUUM BREAKER SINGLE BACK TO BACK FLOOR SLAB PENETRATION

AD ACCESS DOOR FLR FLOOR AFF ABOVE FINISHED FLOOR FPM FEET PER MINUTE AP ACCESS PANEL FT FEET ARCH ARCHITECTURAL GA GAUGE GCO GRADE CLEANOUT BOP BOTTOM OF PIPE GV GATE VALVE BALV BALANCING VALVE GPM GALLONS PER MINUTE BV BALL VALVE HOR HORIZONTAL CAST IRON HW HOT WATER CL CENTER LINE HWR HOT WATER RECIRCULATING CLG CEILING HTR HEATER CLEANOUT CON CONCRETE CV CHECK VALVE HZ HERTZ IN INCHES COLD WATER INS INSULATION DFU DRAIN FIXTURE UNITS KW KILOWATT DOWN LAV LAVATORY MFR MANUFACTURER MAX MAXIMUM DWH DOMESTIC WATER HEATER EACH MIN MINIMUM MS MOP SINK ELEVATION EWC ELECTRIC WATER COOLER NC NORMALLY CLOSED NIC NOT IN CONTRACT DEGREES FAHRENHEIT FLEX FLEXIBLE NO NORMALLY OPEN

FF FINISHED FLOOR

SYMBOLS

ELBOW UP

PIPE CAP

PLUG CLEANOUT

WALL CLEANOUT

ROOF DRAIN

FLOOR CLEANOUT

FIXTURE TRANSFORMER

PLUMBING FIXTURE SCHEDULE

VALVE/FAUCET/TRIM

REDUCED PRESSURE BACKFLOW PREVENTOR

FIXTURE TRAP

SWING CHECK VALVE

—∍

-

—ാഠ

₹

⊣Ō⊢

--1⋅00

—li wco

—⊗ FC0

FIXTURE

ABBREVIATIONS

NPW NON-POTABLE WATER

OFRD OVERFLOW ROOF DRAIN

NTS NOT TO SCALE OD OUTSIDE DIAMETER

OW OPEN WASTE

T&P TEMPERATURE AND PRESSURE RELIEF VALVE TMV THERMOSTATIC MIXING VALVE TOS TOP OF SLAB TYP TYPICAL V VENT VB VACUUM BREAKER VEL VELOCITY VTR VENT THROUGH ROOF WC WATER CLOSET WHA WATER HAMMER ARRESTOR

REFERENCE SYMBOLS

PG PRESSURE GAUGE

PSI PER SQUARE INCH

RPM REVOLUTIONS PER MINUTE

ret return

SF SQUARE FEET

SS SERVICE SINK

TH THERMOMETER

RM ROOM

SK SINK

 $\left\langle \begin{array}{c} XX \\ 1 \end{array} \right\rangle$ EQUIPMENT IDENTIFICATION

FOUNTAIN SHALL BE BLACK COLOR FINISH.

SHOWERHEAD HEIGHT TO BE AT 6'-0".

PLBG LOCATION ADDITIONAL REQUIREMENTS & NOTES QTY SUPPLIES SYMBOL MFR/MODEL MFR/MODEL TYPE TYPE WALL HUNG ELONGATED HARD-WIRED STANDARD RIM HEIGHT. WATER CLOSET 1" ANGLE STOP <u>WC−1</u> REST ROOM 140-1.6 ÉS-S WITH OPEN FRONT SEAT LESS COVER. STAINLESS STEEL CONCEALED SENSOR WITH RIM HEIGHT AT 17-1/2" WALL HUNG ELONGATED HARD-WIRED 1" ANGLE STOP <u>WC-2</u> WATER CLOSET REST ROOM 140-1.6 ES-S WITH OPEN FRONT SEAT LESS COVER. STAINLESS STEEL 1680-W-1 CONCEALED SENSOR WALL HUNG ELONGATED | KOHLER / K-4325 | LIFEGUARD REST ROOM WITH RIM HEIGHT AT 17-1/2" 1" ANGLE STOP <u>₩C-3</u> WATER CLOSET MANUAL EXPOSED CROWN - 111 1.28 GPF WITH OPEN FRONT SEAT LÉSS COVER. HARD-WIRED WITH RIM HEIGHT AT 16". 3/4" ANGLE STOP <u>UR-1</u> 190-1.0-ÉS-S URINAL RESTROOM STAINLESS STEEL 1702-W-1 CONCEALED SENSOR WITH WALL CARRIER. 1.0 GPF SLOAN / 190-1.0-ES-S WALL HUNG STAINLESS STEEL HARD-WIRED WITH STANDARD RIM HEIGHT. 3/4" ANGLE STOP <u>UR-2</u> URINAL 1702-W-1 CONCEALED SENSOR WITH WALL CARRIER. 1.0 GPF CHICAGO FAUCET PUBLIC TOILET ROOMS LOOSE KEY ANGLE WALL HUNG STAINLESS 333-E2805-ACORN / WITH GRID STRAINER <u>LAV-1</u> LAVATORY METERING 1955-1-9-H24-G1 665PSHABCP WITH (2) FAUCETS, (1) FOR HOT & (1) FOR COLD 0.5 GPM CHICAGO FAUCET WALL HUNG VITREOUS CHINA LIFEGUARD REST ROOM LOOSE KEY ANGLE GOOSENECK WITH WITH 0.5 GPM AERATOR AND TMV-1 KOHLER / <u>LAV-2</u> LAVATORY 201-AGN2AE3-317CP WITH GRID STRAINER K-2035-4 WRISTBLADES 0.5 GPM REFER TO ARCHITECTURAL DOCUMENTS MODULAR KITCHENETTE UNIT. ROUTE WATER & WASTE PIPING IN PARTIAL HEIGHT WALL TO LOOSE KEY ANGLE INCLUDED <u>SK-1</u> DWYER UNIT SINK ----OFFICE STOPS FULL HEIGHT WALL BETWEEN LIFEGUARD AND CONCESSION. WALL HUNG STAINLESS GOOSNECK WITH LOOSE KEY ANGLE ELKAY / CONCESSION ELKAY / LKB400 <u>SK-2</u> WITH ELKAY LKB8 STAINLESS STEEL BODY AND GRID STRAINER. HAND SINK CHSB1716C WRISTBLADES TRIPLE BASIN GOOSNECK WITH LOOSE KEY ANGLE WITH ELKAY LK18B STAINLESS STEEL BODY AND GRID STRAINER. <u>SK-3</u> CONCESSION STAINLESS STEEL RNSF8354 WRISTBLADES LK940AT08L2H WITH FD-1 WITH SQUARE GRATE. INTEGRAL STOPS <u>SH-1</u> SHOWER SHOWER PRESSURE BALANCE SYMMONS S-4701-1.5 WITH VALVE ADJUST STOP SCREW FOR OUTLET TEMP MAX: 105°F WITH VACUUM BREAKER AT 7'-6" AFF. SUPPLIES WITH INTEGRAL STOPS. ALL WITH CHICAGO FAUCET 390-PRJKCP LEVER HANDLES. FLOOR MOUNTED LEVER HANDLES AND FIAT / TSB 3000 CHICAGO FAUCET , <u>MB-1</u> MOP BASIN JANITOR PRECAST TERRAZZO SERIES VACUUM BREAKER WITH 1453 FLAT STEEL STRAINER. CONCEALED PIPING. SIZE PER ARCHITECTURAL DOCUMENTS. BARRIER FREE BI-LEVEL WITH PET FOUNTAIN. STAINLESS STEEL HAWS / 3500D LINE VALVE <u>DF-1</u> OUTDOORS PUSH BUTTON

PUSH BUTTON

HAWS

BRADLEY

SUPPLIES WITH

INTEGRAL STOPS.

1. PROVIDE TRANSFORMER (SLOAN EL-154) AS INDICATED ON PLANS FOR HARD WIRED WATER CLOSET'S AND URINALS.

OUTDOOR

SHOWER

<u>0SH-1</u>

DAISY CHAIN AS MANY AS (10) WATER CLOSETS AND URINALS OFF OF (1) SLOAN EL-154 TRANSFORMER.

REFER TO

CIVIL DOCUMENTS

PEDESTAL STAINLESS

BRADLEY /

COL-6B-SV-ST

		•
5	10.27.2009	ISSUED FOR ADDENDUM 4 $\sqrt{4}$
4	9.25.2009	ISSUED FOR BID
3	9.21.2009	ISSUED FOR PERMIT/95% DESIGN

9.04.2009 | ISSUED FOR 90% DESIGN

| 3.31.2009 | ISSUED FOR 30% DESIGN

541 NORTH FAIRBANKS

T: 312.432.4180

F: 312.432.4184

700 N SANGAMON

CHICAGO, IL 60622

© 2005, Muller & Muller, Ltd.

Muller & Muller, Ltd. expressly reserves its common law

plans are not to be reproduced, changed or copied in

any form or manner whatsoever, nor are they to be

assigned to any third party, without firstobtaining the

expressed written consent of Muller & Muller, P.C., Ltd.

100 S. WACKER DRIVE SUITE 700 . CHICAGO IL 60606 . P:312-606-0910 F:312-606-0415

copyright and other property rights in these plans. These

CHICAGO, IL 60611

PROJECT


OSTERMAN BEACH COMFORT STATION CHICAGO, IL

SHEET TITLE

PLUMBING GEN. NOTES, **ABBREVIATIONS & SYMB.**

SHEET NO.

DRAWN: NAP	BDT
CHECKED: TS	MJC
APPROVED: JM	MJC
JOB NO. 09.01.08	

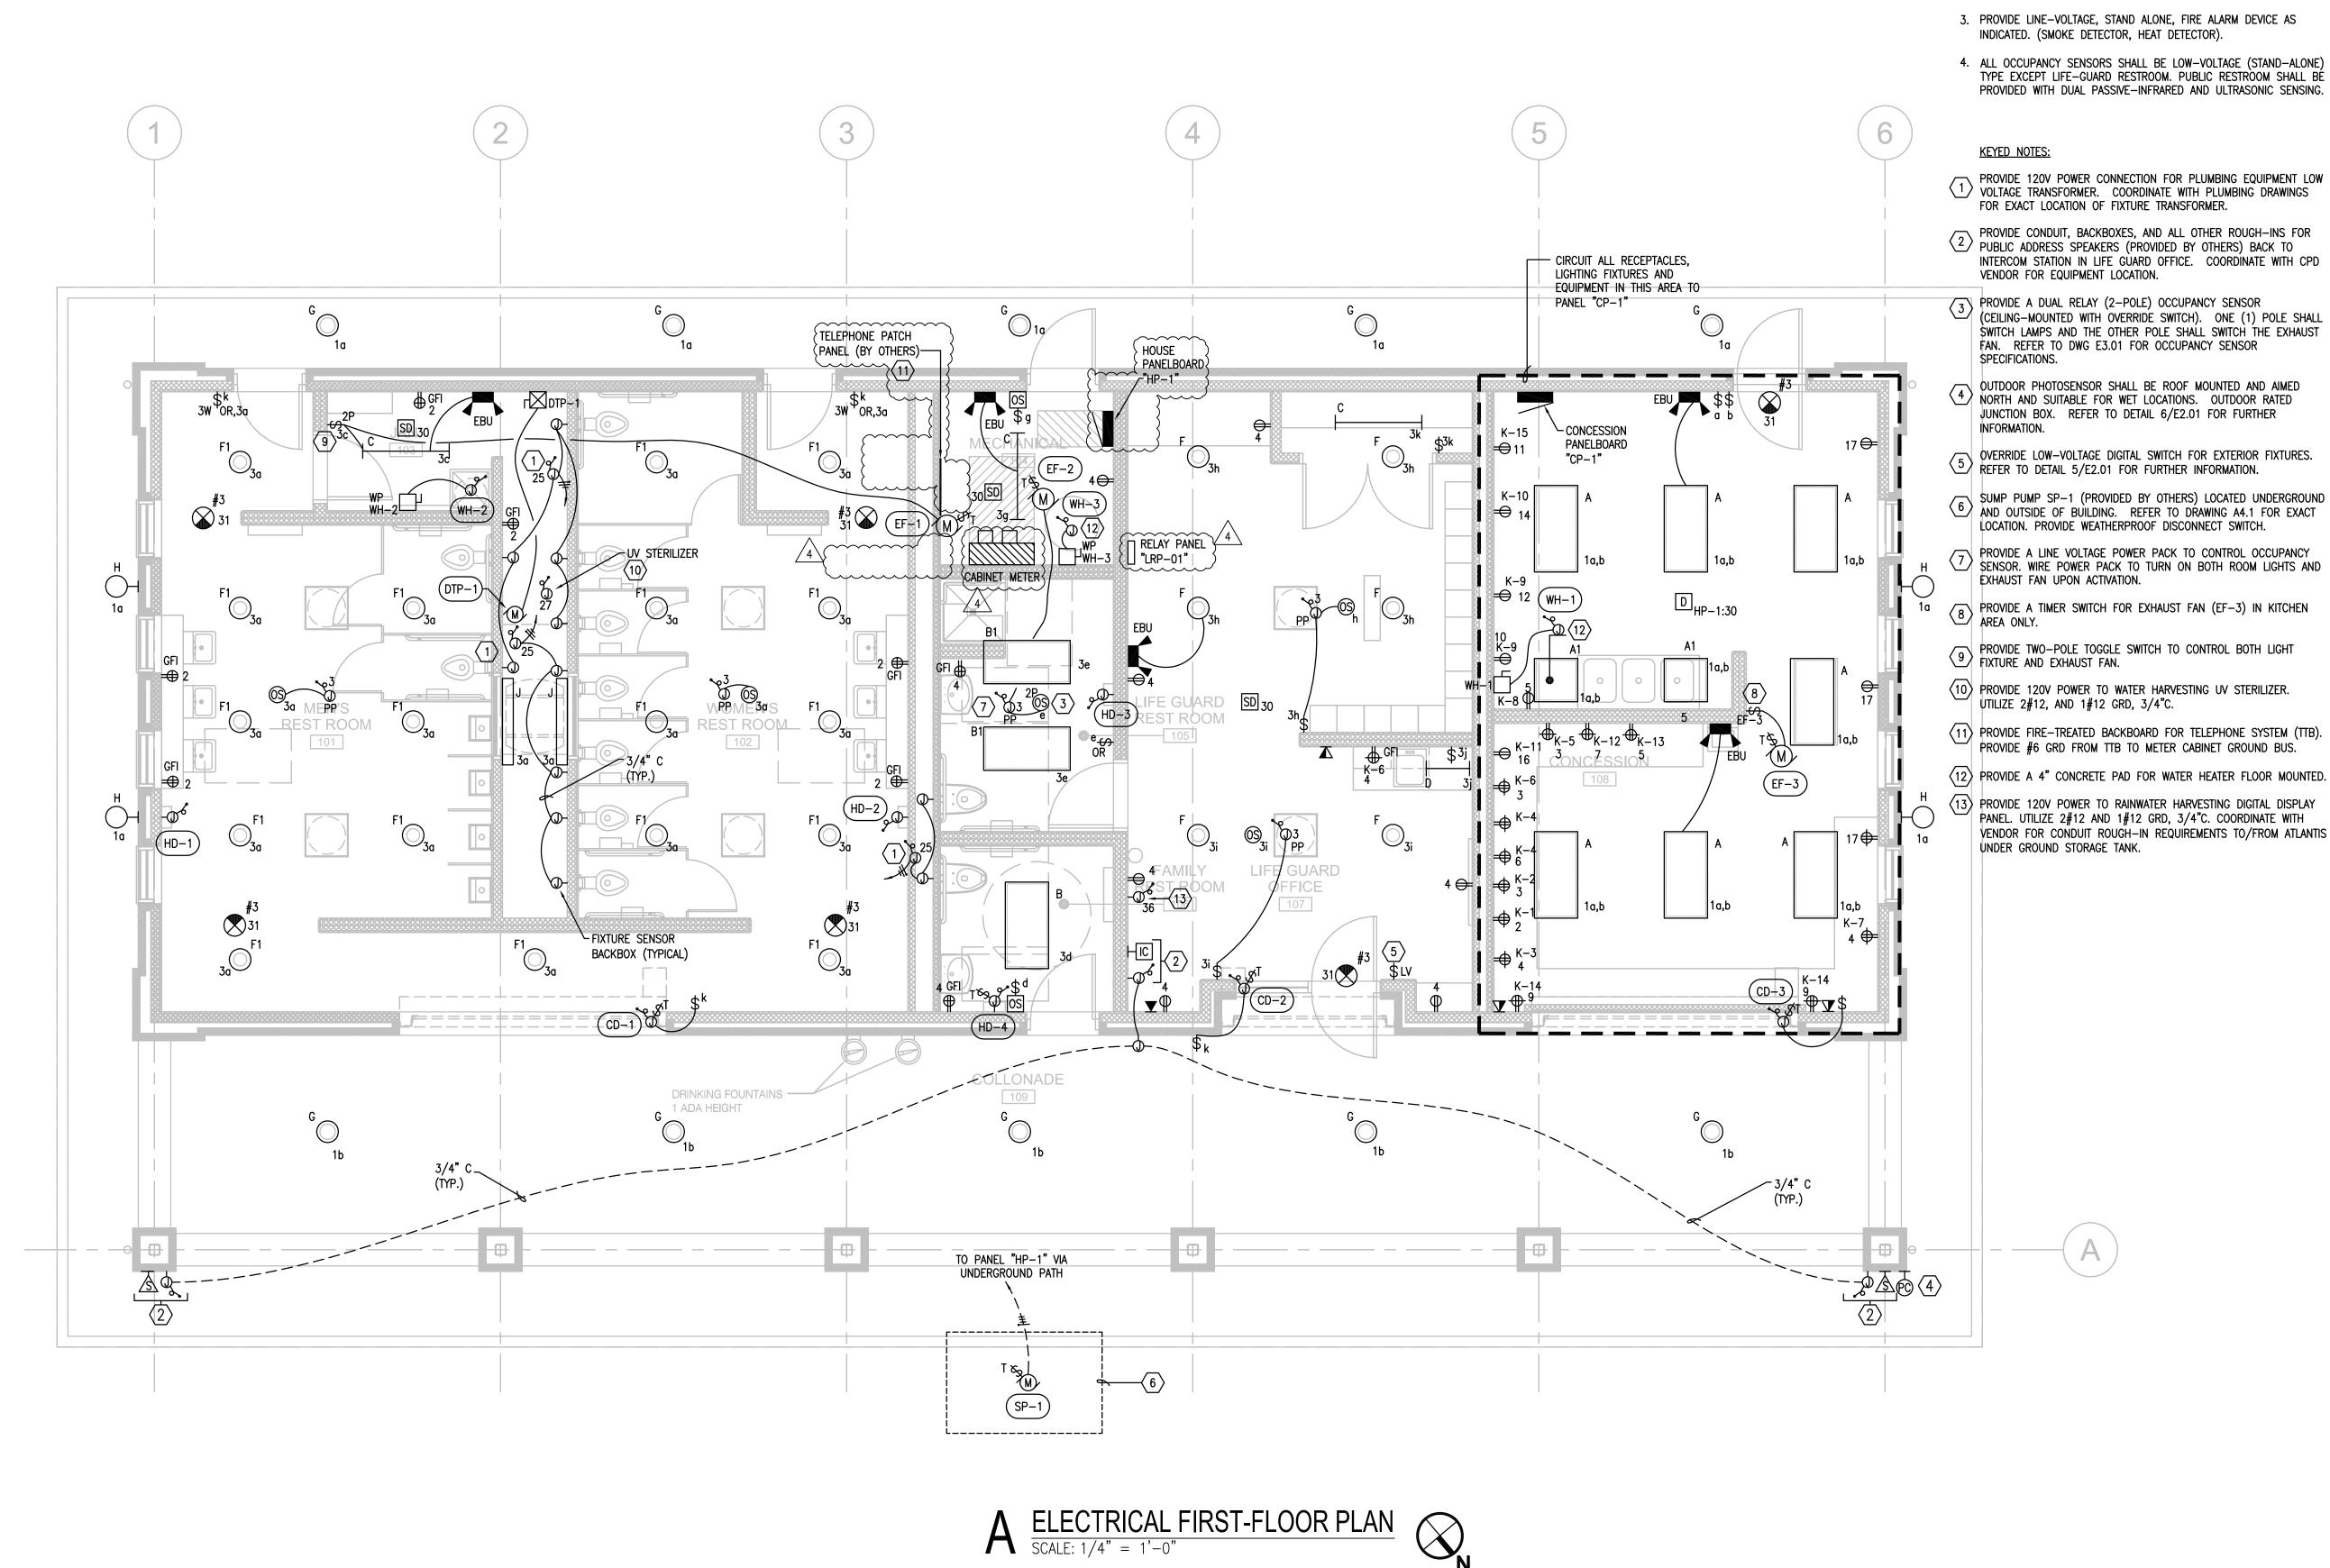

SHEET NOTES:

- 1. WIRE ALL EMERGENCY BATTERY UNITS AHEAD OF NORMAL-POWER LIGHTING FIXTURE.
- 2. CIRCUIT EXTERIOR LIGHTING FIXTURES THROUGH RELAY PANEL.
- 3. PROVIDE LINE-VOLTAGE, STAND ALONE, FIRE ALARM DEVICE AS
- 4. ALL OCCUPANCY SENSORS SHALL BE LOW-VOLTAGE (STAND-ALONE)
- INTERCOM STATION IN LIFE GUARD OFFICE. COORDINATE WITH CPD
- PROVIDE A DUAL RELAY (2-POLE) OCCUPANCY SENSOR (CEILING-MOUNTED WITH OVERRIDE SWITCH). ONE (1) POLE SHALL \$WITCH LAMPS AND THE OTHER POLE SHALL SWITCH THE EXHAUST
- SUMP PUMP SP-1 (PROVIDED BY OTHERS) LOCATED UNDERGROUND AND OUTSIDE OF BUILDING. REFER TO DRAWING A4.1 FOR EXACT

- PANEL. UTILIZE 2#12 AND 1#12 GRD, 3/4"C. COORDINATE WITH VENDOR FOR CONDUIT ROUGH-IN REQUIREMENTS TO/FROM ATLANTIS

PARK 541 NORTH FAIRBANKS CHICAGO, IL 60611

MULLER+MULLER

700 N SANGAMON T: 312.432.4180 CHICAGO, IL 60622 F: 312.432.4184

© 2005, Muller & Muller, Ltd.

Muller & Muller, Ltd. expressly reserves its common law copyright and other property rights in these plans. These plans are not to be reproduced, changed or copied in any form or manner whatsoever, nor are they to be assigned to any third party, without firstobtaining the expressed written consent of Muller & Muller, P.C., Ltd.



	0.01.2000	100025 1 01(00 / 0 52010)(
1	3.31.2009	ISSUED FOR 30% DESIGN
2	9.04.2009	ISSUED FOR 90% DESIGN
3	9.21.2009	ISSUED FOR PERMIT/95% DESIG
4	9.25.2009	ISSUED FOR BID
5	10.12.2009	ISSUED FOR ADDENDUM 1
6	10.27.2009	ISSUED FOR ADDENDUM 4


PROJECT

40TH STREET BEACH COMFORT STATION CHICAGO, IL

SHEET TITLE

ELECTRICAL FIRST-FLOOR PLAN

DRAWN:	МН	SHEET NO.
CHECKED:	PCH	
APPROVED:	DNT	E1.01
IOD NO. 00.04.00		

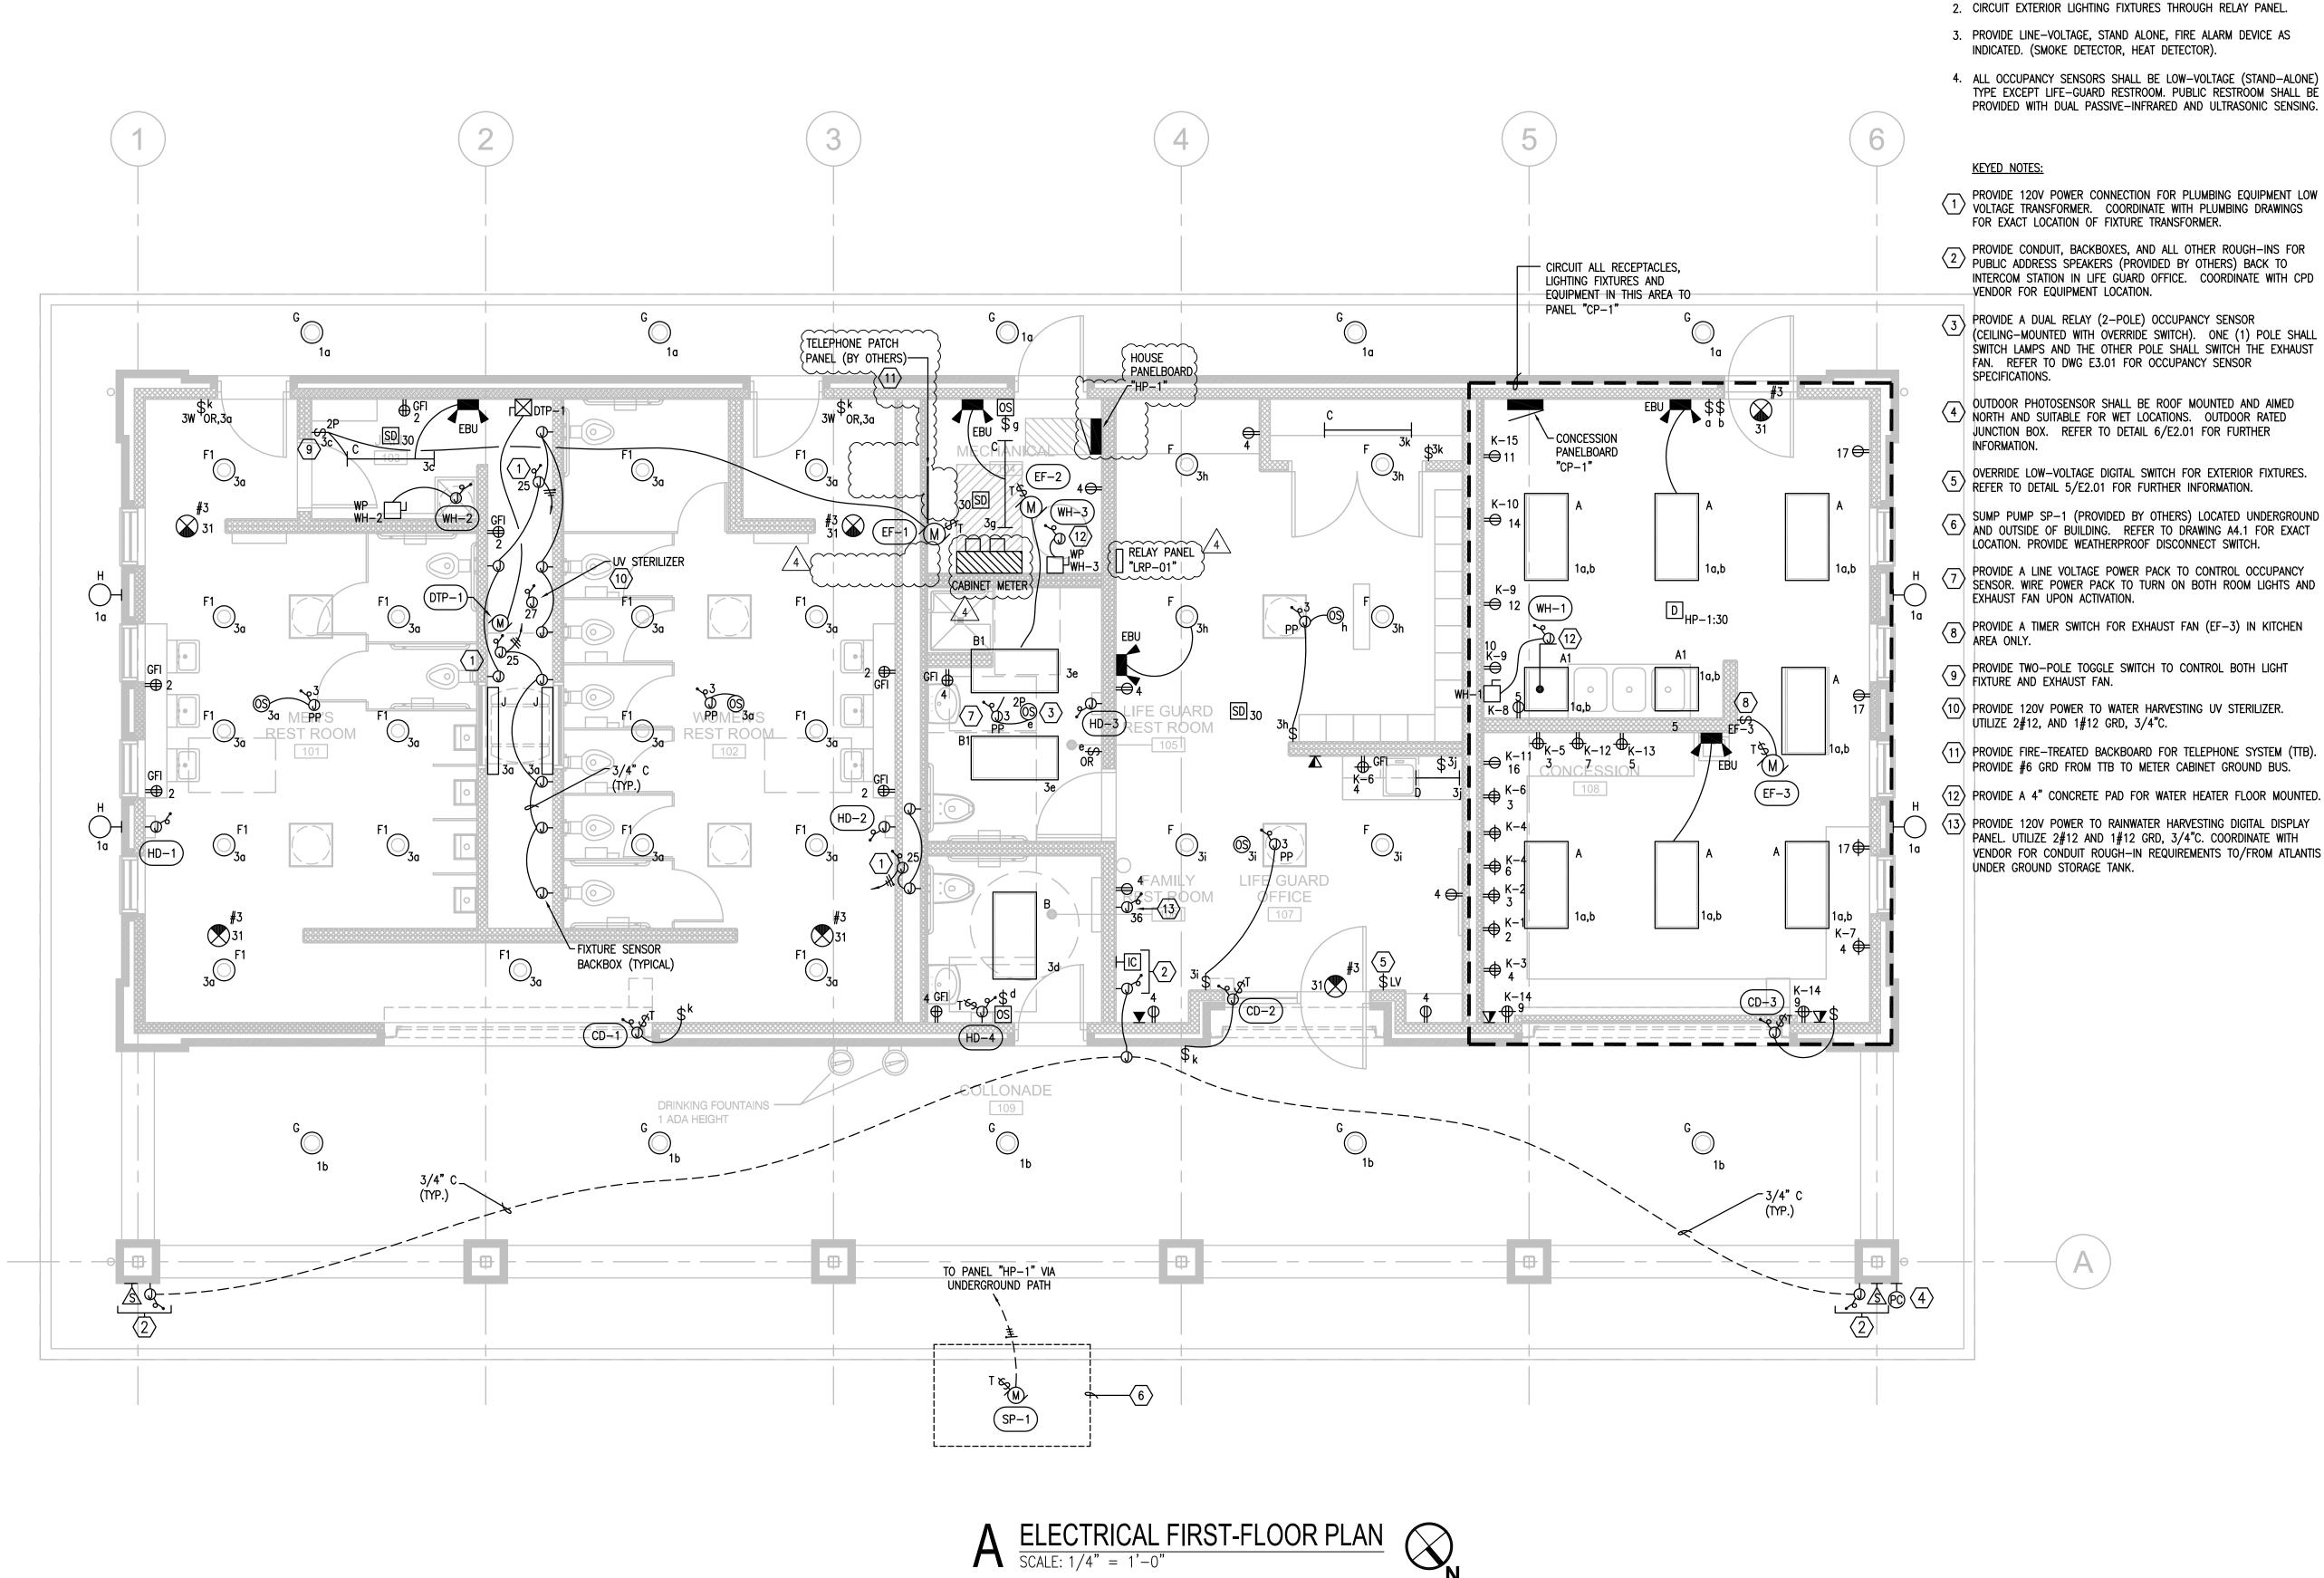

CHICAGO
PARK
DISTRICT

541 NORTH FAIRBANKS
CHICAGO, IL 60611

MULLER+MULLER

700 N SANGAMON CHICAGO, IL 60622

SHEET NOTES:

LIGHTING FIXTURE.

1. WIRE ALL EMERGENCY BATTERY UNITS AHEAD OF NORMAL-POWER

© 2005, Muller & Muller, Ltd.

Muller & Muller, Ltd. expressly reserves its common law copyright and other property rights in these plans. These plans are not to be reproduced, changed or copied in any form or manner whatsoever, nor are they to be assigned to any third party, without firstobtaining the expressed written consent of Muller & Muller, P.C., Ltd.

T: 312.432.4180

F: 312.432.4184

Primera

100 S. WACKER DRIVE SUITE 700 . CHICAGO IL 60606 . P:312-606-0910 F:312-606-0415

6 10.27.2009 ISSUED FOR ADDENDUM 4
5 10.12.2009 ISSUED FOR ADDENDUM 1
4 9.25.2009 ISSUED FOR BID
3 9.21.2009 ISSUED FOR PERMIT/95% DESIGN
2 9.04.2009 ISSUED FOR 90% DESIGN
1 3.31.2009 ISSUED FOR 30% DESIGN


PROJECT


OSTERMAN BEACH COMFORT STATION CHICAGO, IL

SHEET TITLE

ELECTRICAL FIRST-FLOOR PLAN

DRAWN: NAP	MH	SHEET NO.
CHECKED: TS	PCH	
APPROVED: JM	DNT	E 1.01
JOB NO. 09.01.08		

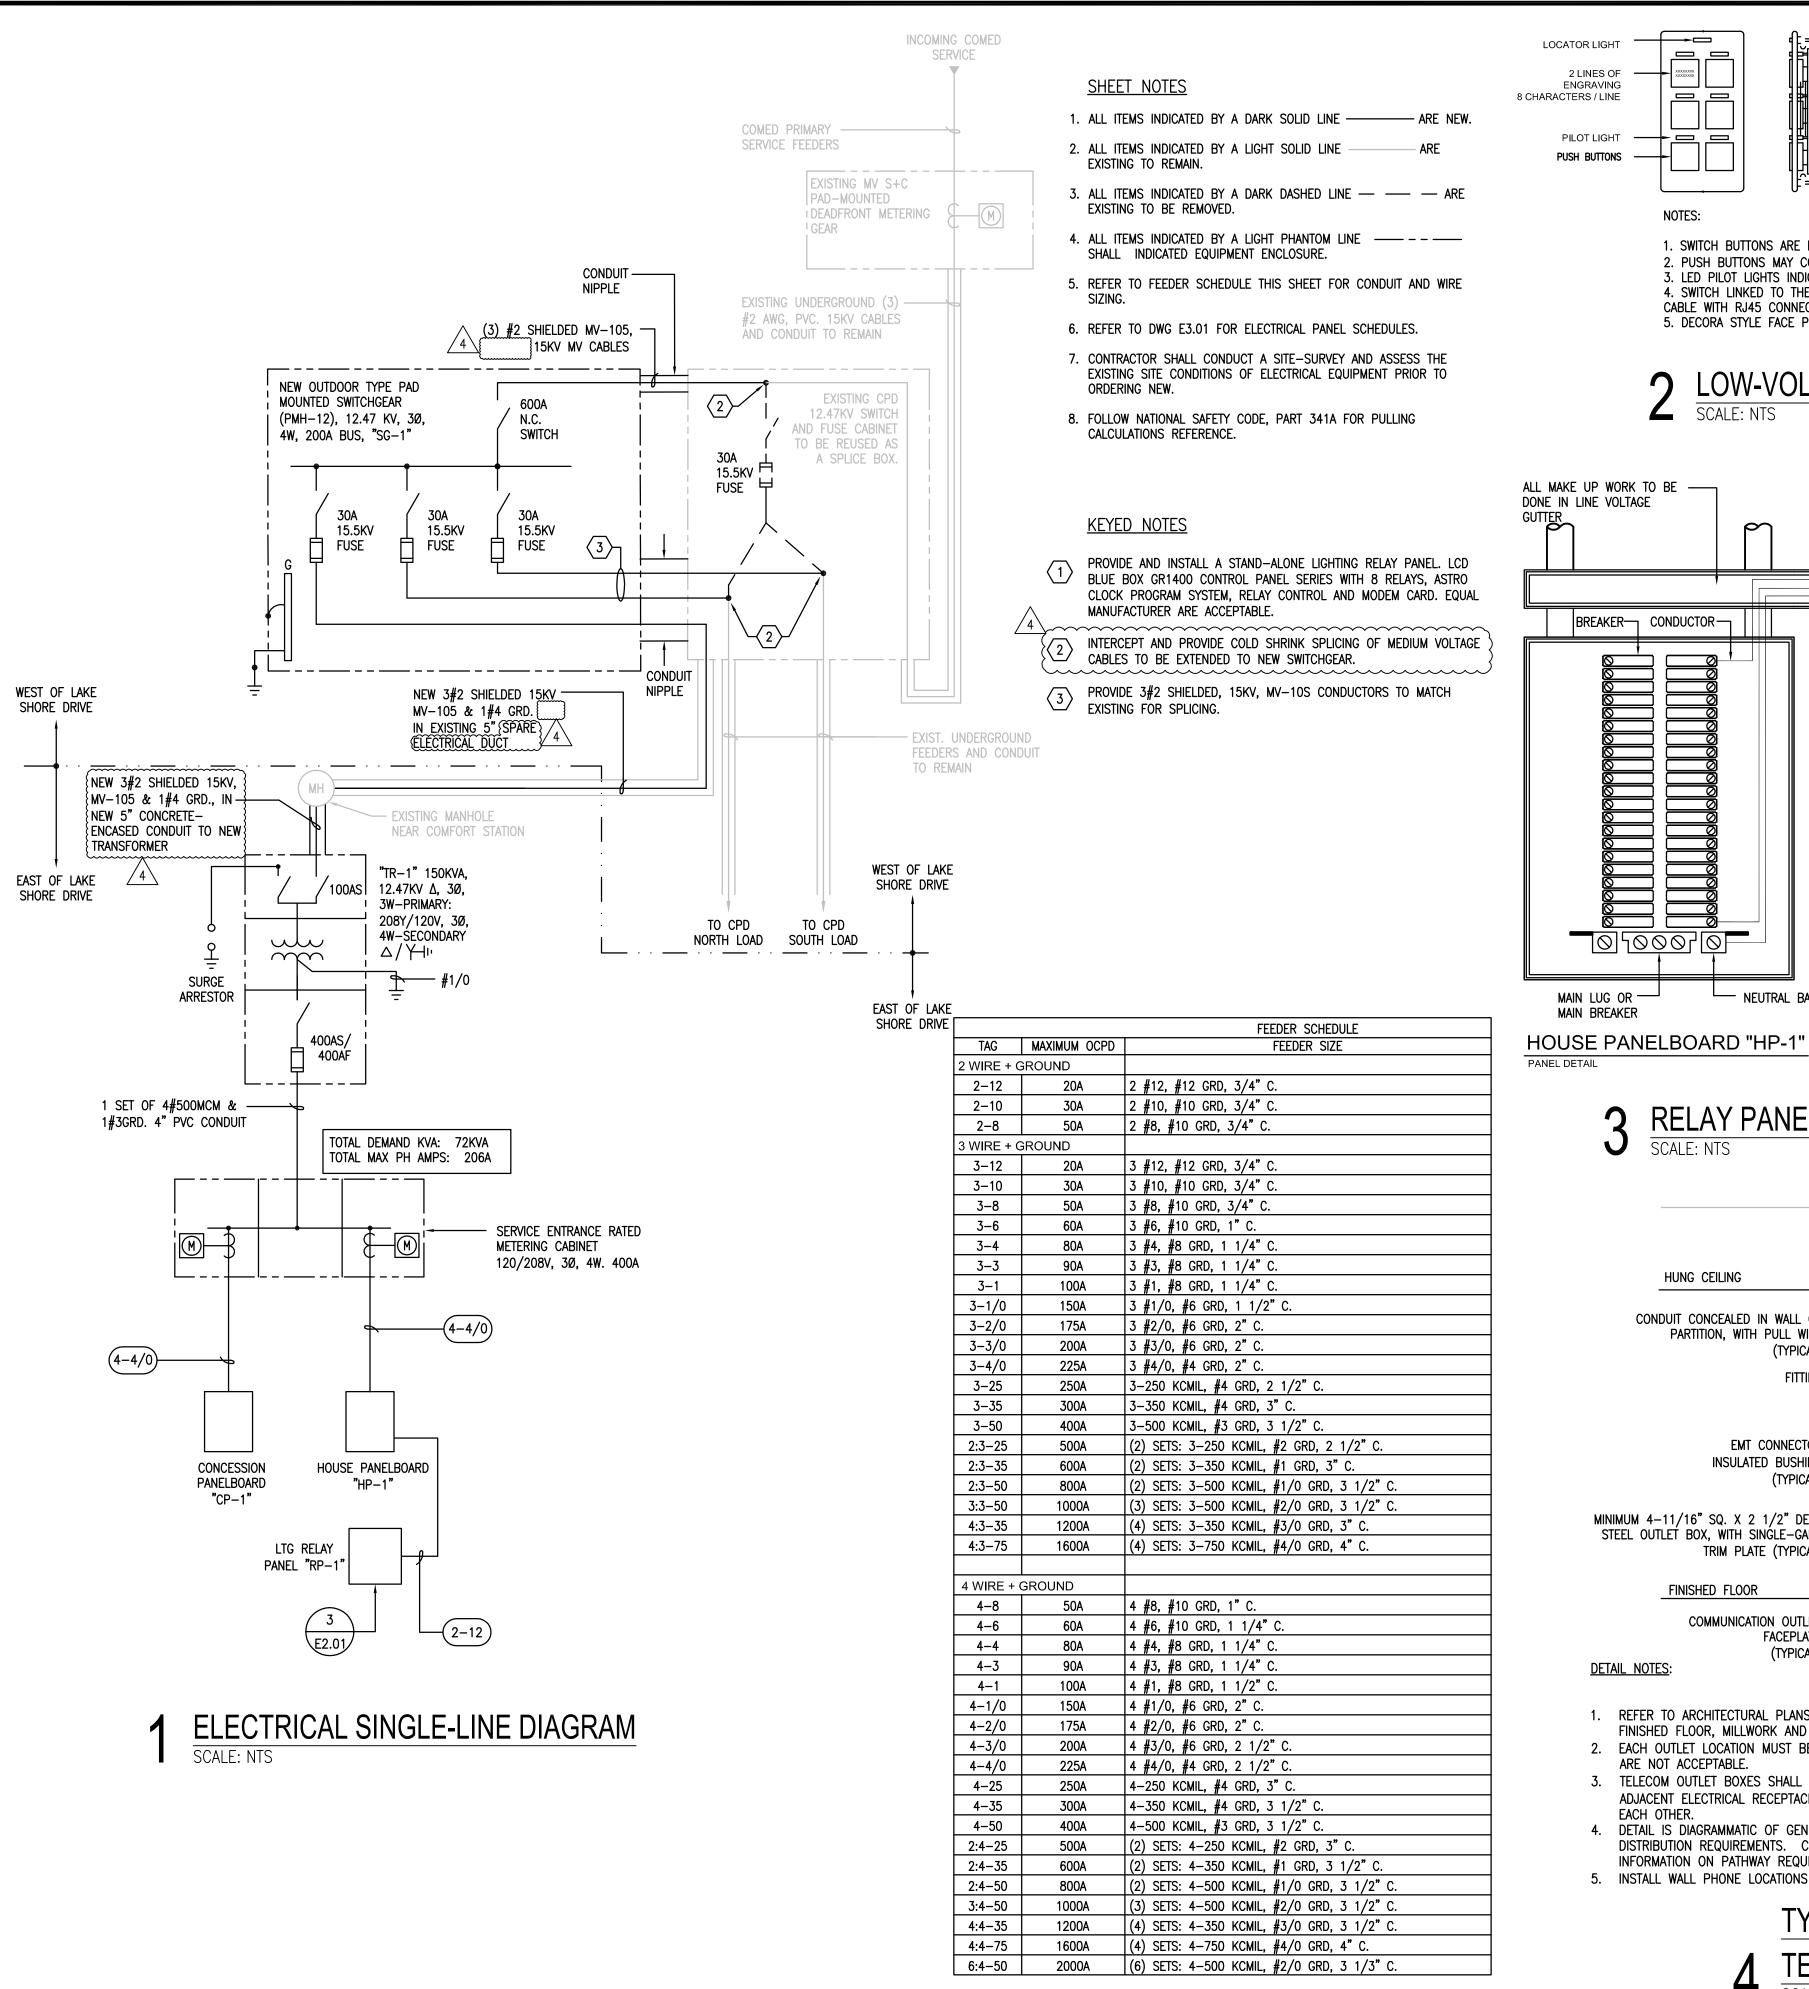


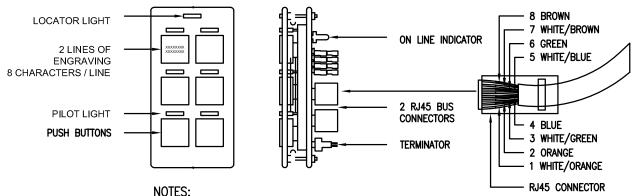

1. SWITCH BUTTONS ARE FACTORY ENGRAVED. 2. PUSH BUTTONS MAY CONTROL ANY RELAY(S) IN ANY COMBINATION. 3. LED PILOT LIGHTS INDICATE STATUS. 4. SWITCH LINKED TO THE GR 1400 DIGITAL BUS VIA CAT. 5 PATCH


CABLE WITH RJ45 CONNECTORS. DECORA STYLE FACE PLATE BY CONTRACTOR.

LOW-VOLTAGE SWITCH DETAIL

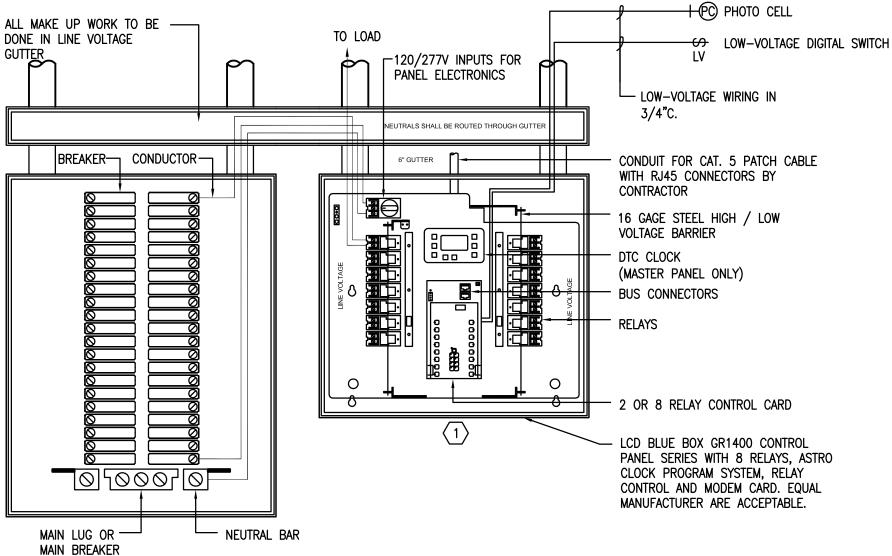


GR 1400 SERIES RELAY PANEL "RP-1"

RELAY PANEL CONNECTION DETAIL

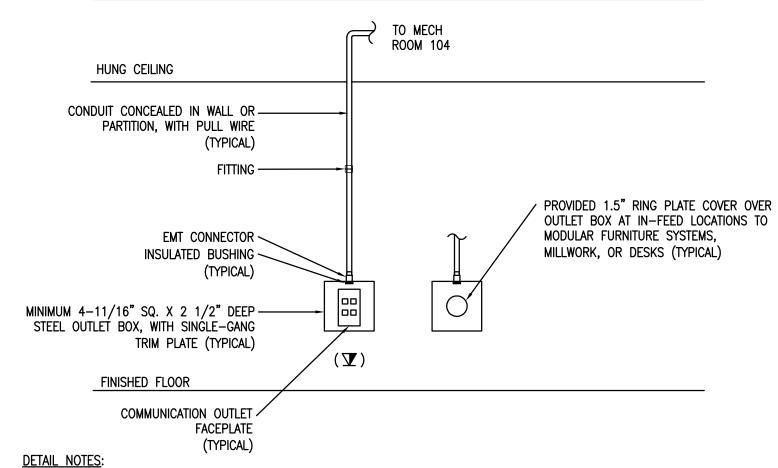

- REFER TO ARCHITECTURAL PLANS FOR INFORMATION REGARDING OUTLET ELEVATION AND PLACEMENT WITH RESPECT TO FINISHED FLOOR, MILLWORK AND FURNITURE.
- EACH OUTLET LOCATION MUST BE SERVED BY A DEDICATED CONDUIT. LOOPED (DAISY-CHAINED) OR BACK-TO-BACK OUTLETS
- 3. TELECOM OUTLET BOXES SHALL BE MINIMUM 4-11/16"x4-11/16"X2-1/2". TELECOM WALL OUTLETS SHALL BE ALIGNED WITH ADJACENT ELECTRICAL RECEPTACLE, AND LOCATED NO MORE THAN 12" FROM RECEPTACLE. INSTALL PLUMB AND LEVEL TO
- DETAIL IS DIAGRAMMATIC OF GENERAL PROJECT CONDITIONS AND IS NOT NECESSARILY INCLUSIVE OF ALL POSSIBLE DISTRIBUTION REQUIREMENTS. CONSULT PROJECT SPECIFICATIONS AND FLOOR PLAN DRAWINGS, WHICH INCLUDE ADDITIONAL INFORMATION ON PATHWAY REQUIREMENTS.
- 5. INSTALL WALL PHONE LOCATIONS AT 42"AFF TO CENTER OF BOX.

TYPICAL CONDUIT STUBS FOR 4 TELECOMMUNICATIONS OUTLETS
SCALE: NTS

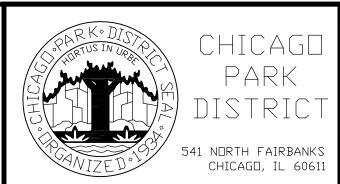

MULLER+MULLER

700 N SANGAMON T: 312.432.4180 CHICAGO, IL 60622 F: 312.432.4184

2005, Muller & Muller, Ltd.

Muller & Muller, Ltd. expressly reserves its common law copyright and other property rights in these plans. These plans are not to be reproduced, changed or copied in any form or manner whatsoever, nor are they to be assigned to any third party, without firstobtaining the expressed written consent of Muller & Muller, P.C., Ltd.



6	10.27.2009	ISSUED FOR ADDENDUM 4
5	10.12.2009	ISSUED FOR ADDENDUM 1
4	9.25.2009	ISSUED FOR BID
3	9.21.2009	ISSUED FOR PERMIT/95% DESIGN
2	9.04.2009	ISSUED FOR 90% DESIGN
1	3.31.2009	ISSUED FOR 30% DESIGN

PROJECT

40TH STREET BEACH COMFORT STATION CHICAGO, IL

SHEET TITLE

ELECTRICAL SINGLE-LINE DIAGRAM

DRAWN:	MH	SHEET NO.
CHECKED:	PCH	
APPROVED:	DNT	EZ.U1
JOB NO. 09.01.08		