

7. THE SURVEY BASE PROVIDED HEREIN IS FOR INFORMATIONAL PURPOSES ONLY. THE OWNER/ARCHITECT/ENGINEER ARE NOT RESPONSIBLE FOR ANY MISCHARTED OF UNCHARTED UTILITIES, OR OTHER ERRORS DETECTED. IT IS THE RESPONSIBILITY OF THE CONTRACTOR TO VERIFY ALL SITE CONDITIONS.
8. THE CONTRACTOR WILL PROTECT ALL UTILITIES DESIGNATED TO REMAIN. ANY DAMAGE BY THE CONTRACTOR TO UTILITIES, ALLEYS, STREETS OR ADJACENT PROPERTIES WILL BE REPLACED/REPAIRED AT THE CONTRACTORS EXPENSE.
9. THE CONTRACTOR WILL PAY ALL REQUISITE FEES TO THE CITY OF CHICAGO, IL AND ANY OTHER AGENCY REQUIRED FOR COMPLETION OF DEMOLITION WORK.
10. IT IS THE CONTRACTOR'S RESPONSIBILITY TO REMOVE ALL EXISTING SERVICES AND APPURTENANCES TO DEMOLISHED SITE FEATURES AND CAP/TERMINATE AS REQUIRED BY THE UTILITY COMPANY. CONTRACTOR SHOULD CONTACT ARCHITECT/ENGINEER IF ANY QUESTION ARISES REGARDING THE VIABILITY OF A UTILITY STRUCTURE.
11. REMOVE EXISTING BELOW-GRADE OBSTRUCTIONS AS REQUIRED FOR THE COMPLETION OF NEW CONSTRUCTION, COORDINATE REMOVAL OF EXISTING OBSTRUCTIONS WITH SPECIFICATION SECTION "SITE CLEARING" AND APPROPRIATE SECTIONS OF THE CONTRACT DOCUMENTS FOR THE NEW WORK.
12. CONTRACTOR SHALL RECYCLE CLEAN CONSTRUCTION DEBRIS IN ACCORDANCE WITH SPECIFICATION SECTION 01524 AND AS PERMITTED BY SPECIFICATION SECTIONS 02316.
13. ALL SOILS AND CONSTRUCTION AND DEMOLITION DEBRIS SHALL BE HANDLED IN ACCORDANCE WITH ENVIRONMENTAL REQUIREMENTS. REFER TO SPECIFICATION SECTIONS 02316.
14. ~~THE CONTRACTOR SHALL EXCAVATE, REMOVE, AND DISPOSE OF SOILS INCLUDING NON-SPECIAL WASTE SOILS AND NON-HAZARDOUS SPECIAL WASTE SOILS), FILL, BACKFILL, TOPSOIL, CU STRUCTURAL SOIL, AND GENERAL CONSTRUCTION AND DEMOLITION DEBRIS TO DEPTHS REQUIRED TO COMPLETE THE CONSTRUCTION WORK ACTIVITIES AS SPECIFIED IN THE ARCHITECT/ENGINEERING DRAWINGS AND SPECIFICATIONS.~~
15. NATIVE CLAY MATERIALS OBTAINED FROM 20 FEET OR MORE BELOW THE ELEVATION OF 13.17 CITY OF CHICAGO DATUM AND WITH THE EXCEPTION OF AREA D SHOWN ON DRAWING ENV.1 MAY BE USED ONSITE IN ACCORDANCE WITH CONTRACT SPECIFICATIONS OR CAN BE SENT TO AN OPEN, ACTIVE, AND PERMITTED CCDD OPERATION FACILITY IN ACCORDANCE WITH SPECIFICATION SECTION 02316.



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### CHANGES TO DEMOLITION NOTES

DISTRICT 12 POLICE STATION

Sheet No: C1.1  
Date: 07/02/10

**CSK-01**

Plot Date: 10/17/2008



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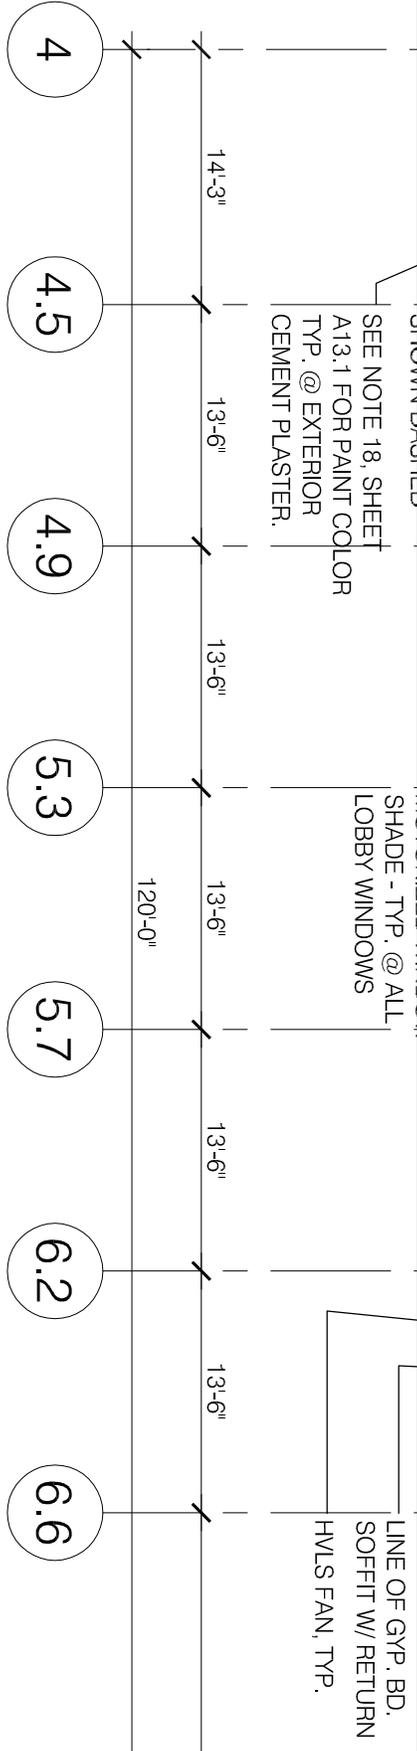
**PUBLIC BUILDING COMMISSION OF CHICAGO**  
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 CHICAGO, IL 60602

**12th DISTRICT POLICE STATION**  
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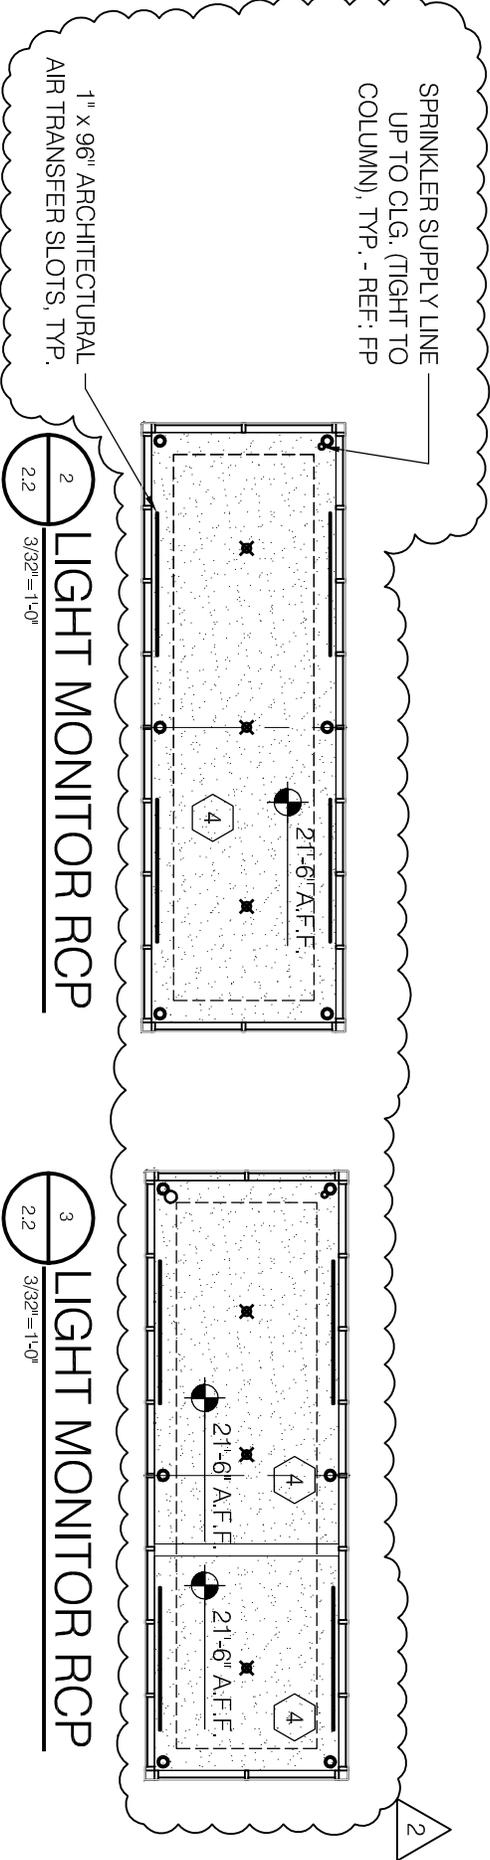
SCALE: AS NOTED

DATE: 07/02/2010  
 DRAWN BY: LJH  
 CHECKED BY: KMC

SHEET: **ASK.05**  
 REFERENCE: A2.2



**1 SECOND FLOOR REFLECTED CEILING PLAN**  
 2.2 3/32"=1'-0"



**2 LIGHT MONITOR RCP**  
 2.2 3/32"=1'-0"

**3 LIGHT MONITOR RCP**  
 2.2 3/32"=1'-0"

# DOOR SCHEDULE

FLOOR	OPNG NO	TYPE	DOOR				MAT	HDW SET	TYPE	MAT	FRAME			GLAZING	LABEL	NOTE KEY
			WIDTH	HT	THK	TRANS					HEAD	JAMB	SILL			
	100-A	B	3'-0"	8'-0"	1 3/4"	-	SS 901	F01	AL	-	-	-	G2	-	-	7,N6,N3,10
	100-B	B	3'-0"	8'-0"	1 3/4"	-	AL 001/803	F01	AL	3/A5.3	5/A6.1 SIM	3/A6.7	G1-B	-	-	7,N6,N3,10
	100-C	K	3'-0"	3'-8"	-	-	SS 903	-	-	-	7/A6.2A	-	-	-	-	N11
	100-D	K	3'-0"	3'-8"	-	-	SS 903	-	-	-	7/A6.2A	-	-	-	-	N11
	100-E	K	3'-0"	3'-8"	-	-	SS 904	-	-	-	7/A6.2A	-	-	-	-	-
	102-A	A	3'-0"	8'-8"	1 3/4"	-	HM 398/804	F01	HM	1/A12.2	1/A12.2	1/A12.2	-	-	-	7
	119-A	A	3'-0"	8'-6"	1 3/4"	-	HM 304	F05	HM	1/A12.2	2/A6.2A	-	G2	-	-	-
	120-A	A	3'-0"	8'-6"	1 3/4"	-	HM 205	F01	HM	1/A12.2	1/A12.2	1/A12.2	-	-	-	N4,N12
	122-A	J	3'-0"	8'-6"	1 3/4"	-	HM 104	F25	HM	1/A12.2	1/A12.2	1/A12.2	-	-	-	G6 B
	122-B	J	3'-0"	8'-0"	1 3/4"	-	HM 002/805	F01	HM	3/A6.8	4/A6.2A	3/A6.7 SIM	G1-A	-	-	7,N3,N13
	129-D		9/12.2	7'-4"	-	-	STL 902	-	-	-	12/12.2 SIM	-	-	-	-	-
	129-E		10/12.2	7'-4"	-	-	STL 905	-	-	-	11/12.2	-	-	-	-	-
	129-F		9/12.2	7'-10"	-	-	STL 902	-	-	-	12/12.2 SIM	-	-	-	-	-
	129-G		9/12.2	7'-10"	-	-	STL 902	-	-	-	12/12.2 SIM	-	-	-	-	-
	129-H		10/12.2	4'-6"	-	-	STL 905	-	-	-	11/12.2	-	-	-	-	-
	130-A	A	3'-0"	7'-10"	1 3/4"	-	HM 297	F01	HM	1/A12.2	1/A12.2	1/A12.2	-	-	-	B
	184-A	B	3'-0"	8'-6"	1 3/4"	-	HM 101/805	F13	HM	1/2/A12.2	1/2/3/A12.2	-	G5	-	-	10
	185-A	B	3'-0"	8'-6"	1 3/4"	-	AL 104	F13	AL	15/A12.2	16/A12.2	-	G1-A	-	-	-
	185-B	B	3'-0"	8'-0"	1 3/4"	-	AL 007/805	-	AL	3/A5.3	5/A6.1 SIM	3/A6.7	G1-A	-	-	7,N3,10
	186-A	-	-	-	-	-	-	-	-	-	-	-	-	-	-	-
	187-A	A	3'-0"	8'-6"	1 3/4"	-	HM 207/804	F14	HM	1/A12.2	1/2/3/A12.2	1/2/3/A12.2	G2	-	-	-
	188-A	A	3'-0"	8'-6"	1 3/4"	-	HM 207	F01	HM	1/A12.2	1/A12.2	1/A12.2	-	-	-	N1
	212-A	A	3'-0"	8'-0"	1 3/4"	-	HM 403	F02	HM	1/A12.2	1/A12.2	1/A12.2	-	-	-	-
	213-A	A	3'-0"	8'-6"	1 3/4"	-	HM 207	F01	HM	1/A12.2	1/A12.2	1/A12.2	-	-	-	B
	214-A	J	3'-0"	8'-6"	1 3/4"	-	HM 104	F25	HM	1/A12.2	1/A12.2	1/A12.2	-	-	-	G6 B
	216-A	A	3'-0"	8'-6"	1 3/4"	-	HM 207	F01	HM	1/A12.2	1/A12.2	1/A12.2	-	-	-	N4,N12

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**12th DISTRICT POLICE STATION**  
 1412 SOUTH BLUE ISLAND AVENUE  
 CHICAGO, IL 60608

DESCRIPTION: UPDATED DOOR SCHEDULE

REVISION: ISSUED FOR ADDENDUM 1

SCALE: N.T.S.

DATE: 06/21/2010

DRAWN BY: LJH

CHECKED BY: KMC

SHEET: **ASK.06**

REFERENCE: A12.1

Plot Date: 10/17/2008

Plot Date: 10/17/2008



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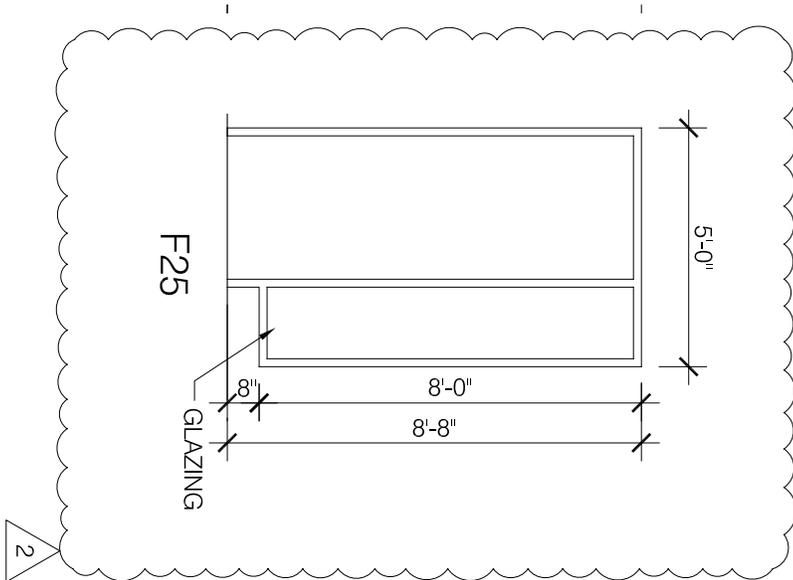
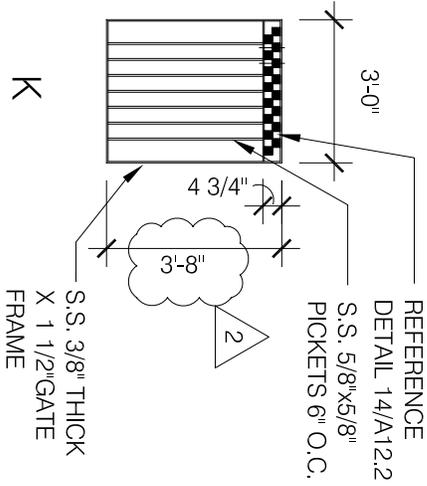
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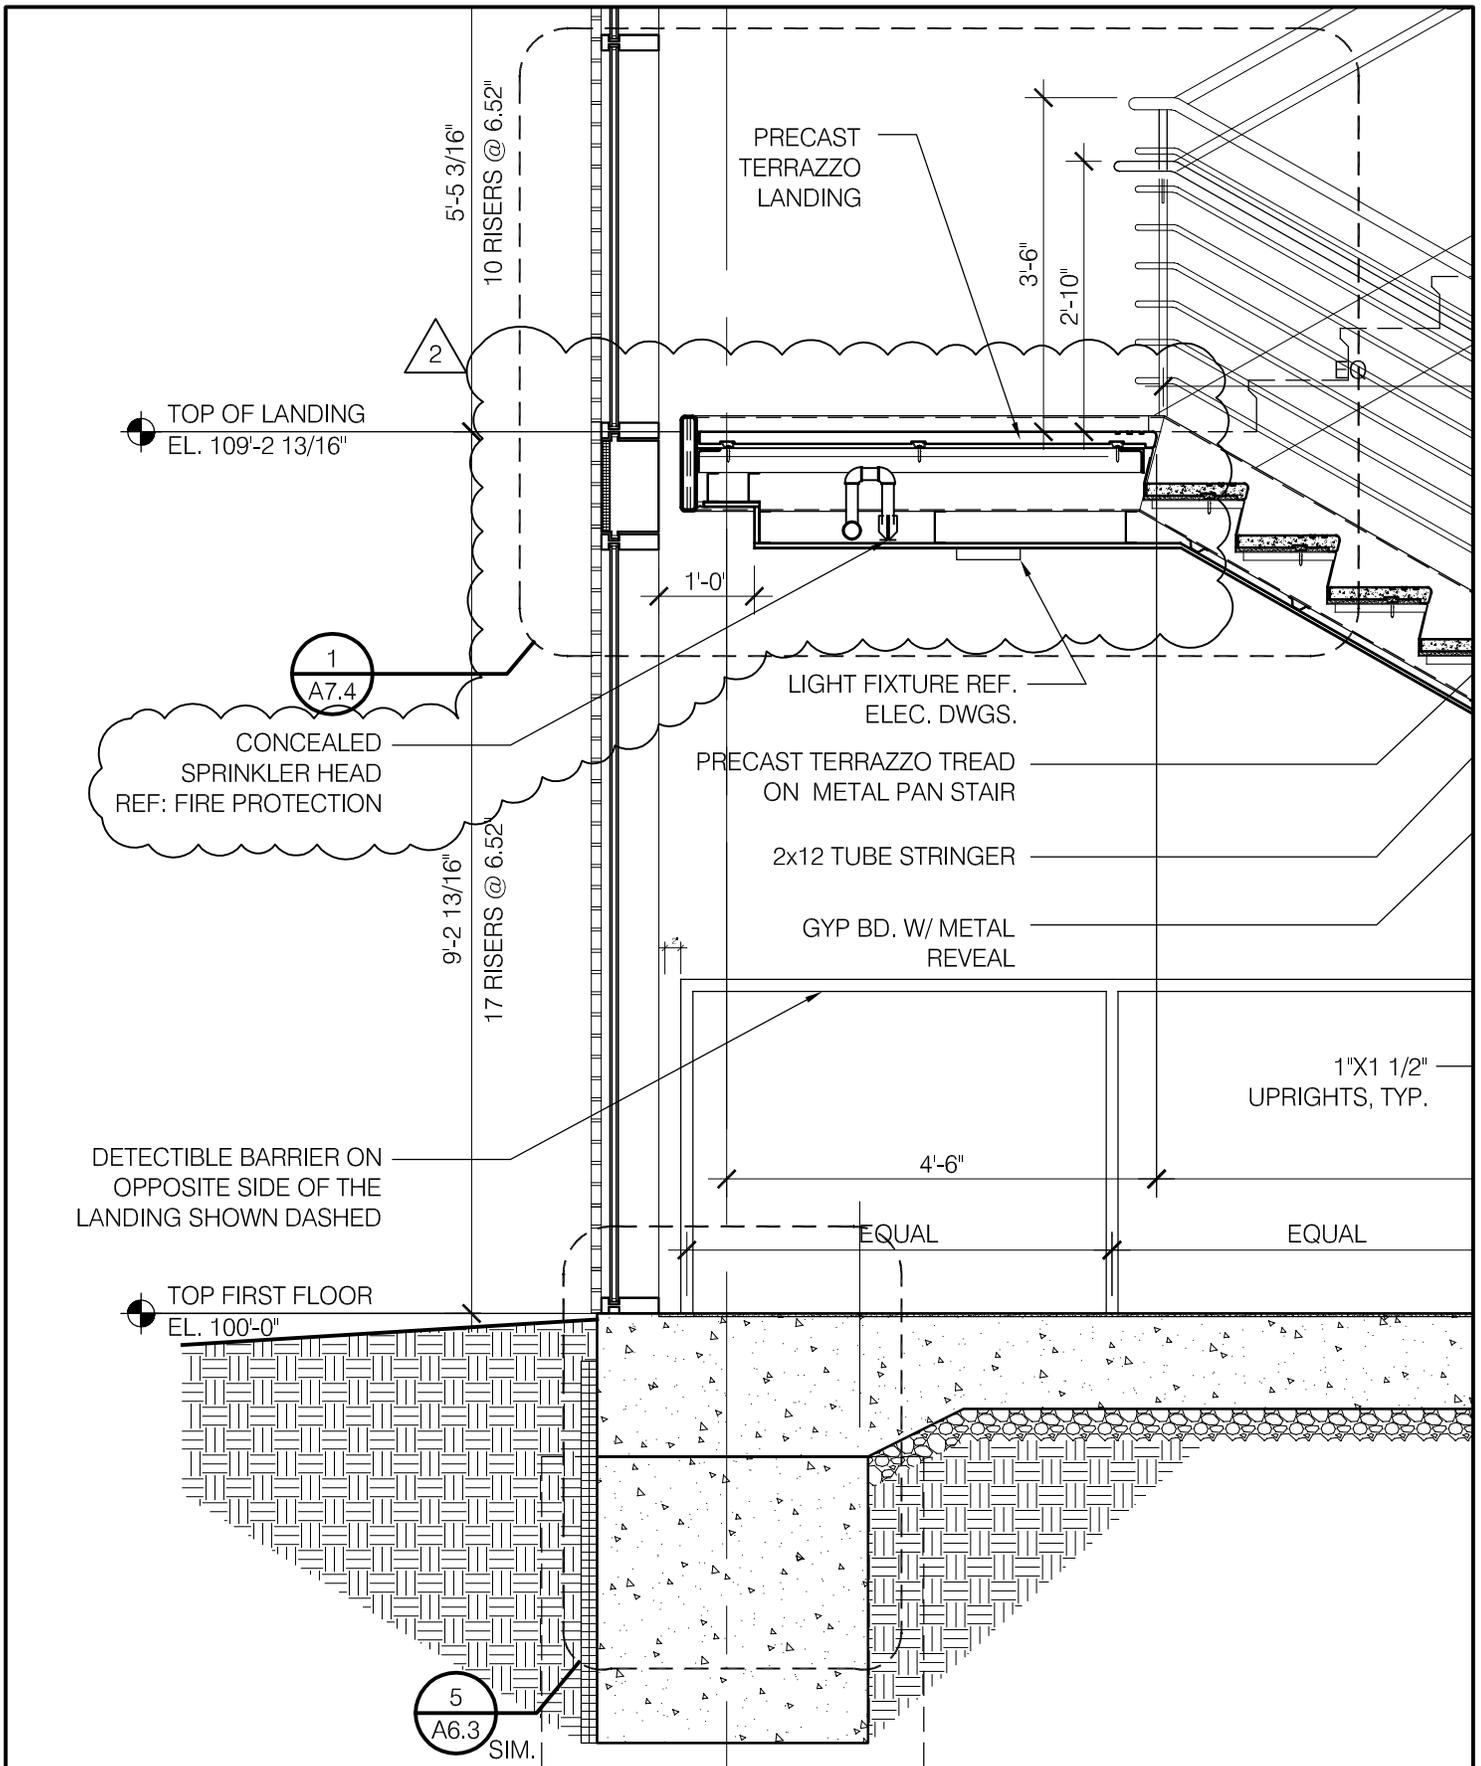
SCALE: 1/4" = 1'-0"  
 DATE: 06/21/2010

DRAWN BY: LJH  
 CHECKED BY: KMC

SHEET: **ASK.07**  
 REFERENCE: **A12.2**




FILE: U:\2443h-00 12th District Police Station Drawings\Sheets\ASKs\ASK10.dwg



<p><b>VOA ASSOCIATES, INC.</b>          Architecture/Planning/Interior Design          224 South Michigan Avenue # 1400          Chicago, Illinois 60604          PH: (312)554-1400 FAX:(312)554-1412</p>	<p>PUBLIC BUILDING COMMISSION OF CHICAGO          50 WEST WASHINGTON STREET, CHICAGO, IL 60602          12th DISTRICT POLICE STATION          1412 SOUTH BLUE ISLAND AVENUE, CHICAGO, IL 60608</p>	<p>SCALE:          1/2" = 1'-0"</p>	<p>DRAWN BY:          LJH</p>	<p>SHEET:  <b>ASK.10</b></p>
	<p>DESCRIPTION:          UPDATED WALL SECTION</p>	<p>REVISION:          ADDENDUM 2</p>	<p>DATE:          07/02/2010</p>	<p>CHECKED BY:          KMC</p>

PRINTED: 07/07/2010

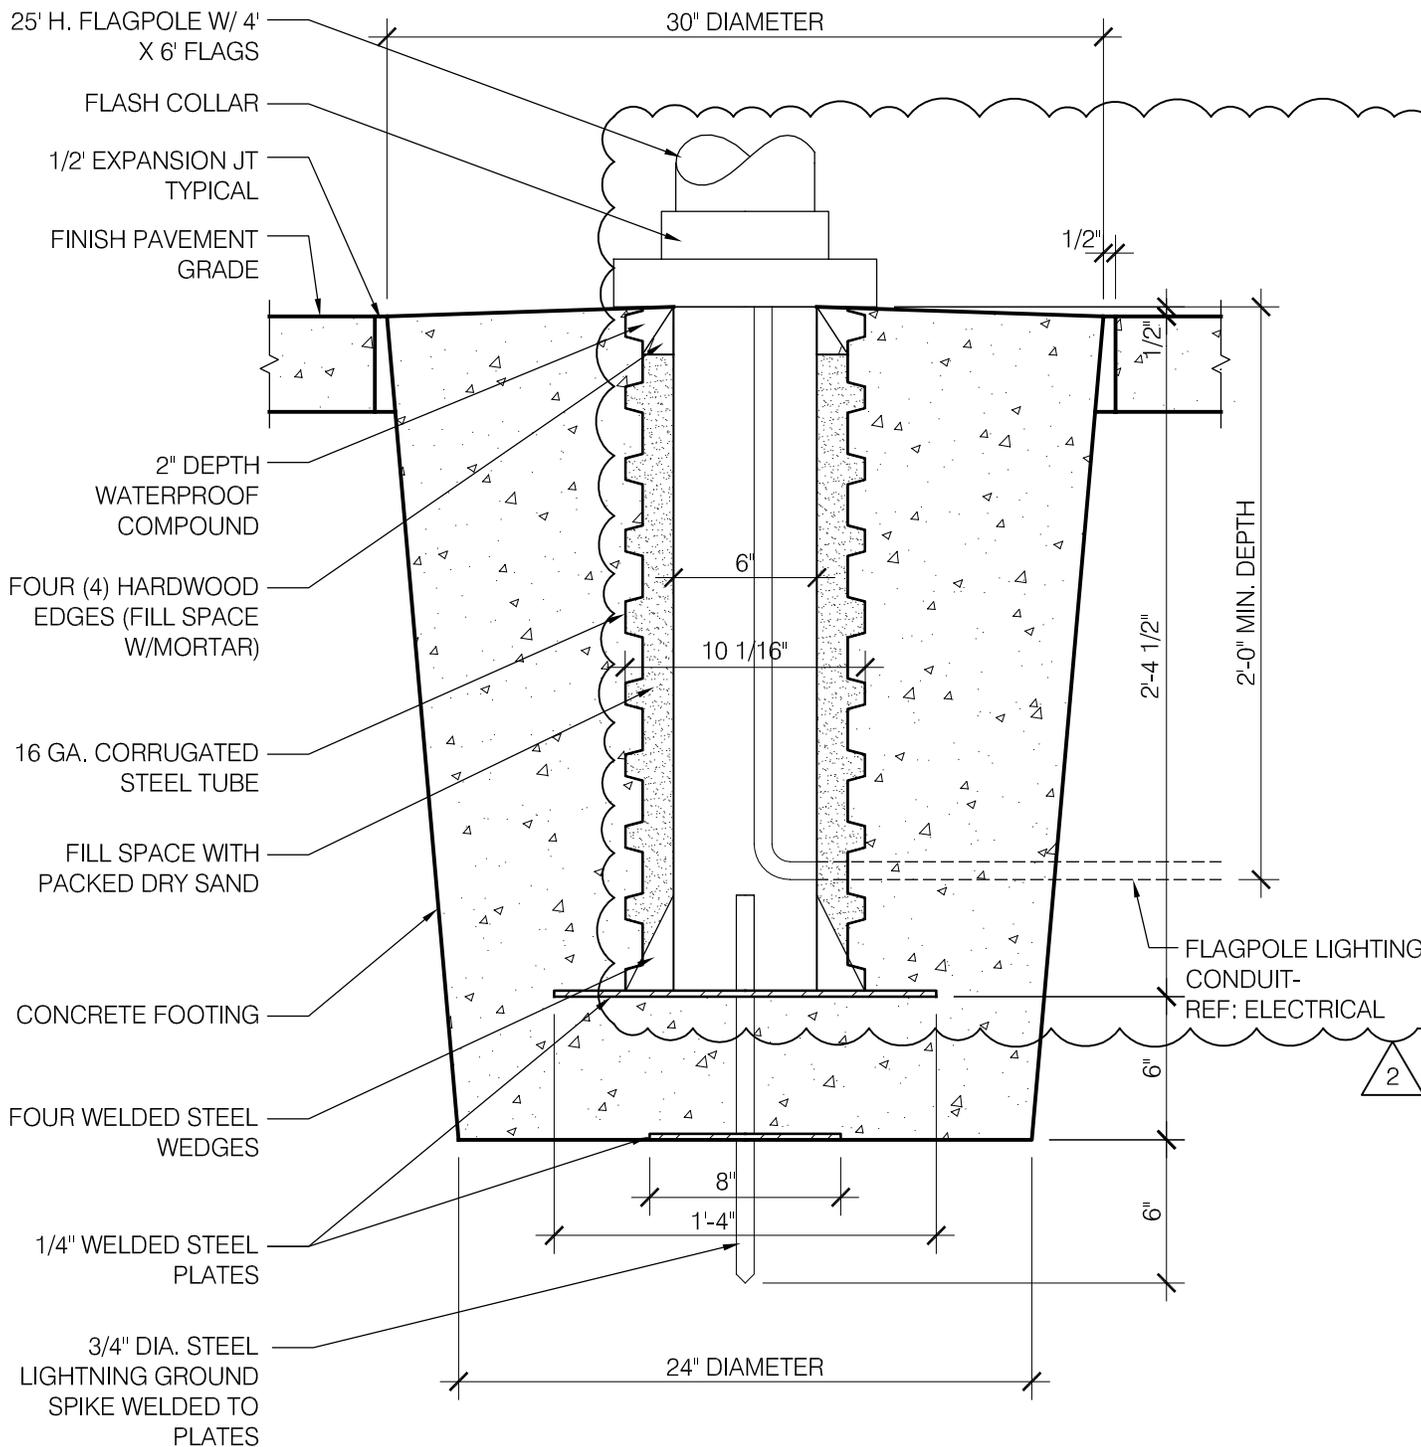

6  
AS4.1

# DETAIL @ FLAGPOLE

1 1/2" = 1'-0"

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DESCRIPTION:  
 UPDATED DETAIL @ FLAGPOLE

REVISION:  
 ADDENDUM 2

SCALE:  
 AS NOTED  
 DATE:  
 07/02/2010

DRAWN BY:  
 LJH  
 CHECKED BY:  
 KMC

SHEET:  
**ASK.20**  
 REFERENCE:  
**AS4.1**

# NOTES LEGEND :

## 100. TYPICAL MASONRY WALL AND CONCRETE FOUNDATION :

- 100-A FACE BRICK
- 100-B 1 1/4" AIR SPACE
- 100-C 1/2" CAVITY WALL INSULATION
- 100-D 8" CONCRETE MASONRY UNIT W/SELF ADHERING AIR & WATER MEMBRANE
- 100-E LIMESTONE TRIM W/SELF ADHERING AIR & WATER MEMBRANE
- 100-F 2" CONTINUOUS CHARCOAL COLOR EGGSHELL COLOR
- 100-G S.S. SPLIT END CRAMP ANCHOR AT EACH VERTICAL JOINT
- 100-H THROUGH WALL FLASHING W/S.S. DRIP EDGE
- 100-I WEEP VENTILATOR - 2" O.C.

## 101. TYPICAL CONCRETE FOUNDATION AND FLOOR SLAB :

- 101-A CONCRETE FOUNDATION REF. STRUCT
- 101-B CONCRETE FLOOR SLAB REF. STRUCT
- 101-C GROUT
- 101-D NOT USED
- 101-E UNDETERMINED MATERIAL
- 101-F 4" DEEP x 2" THK. PERIMETER INSULATION
- 101-G TERRAZZO FLOOR FINISH
- 101-H 2" THK. CONCRETE TOPPING SLAB

## 103. TYPICAL LIMESTONE SILL AT ALUMINUM WINDOW WALL :

- 103-A LIMESTONE TRIM WITH DRIP EDGE
- 103-B 1 1/4" AIR SPACE
- 103-C 2 1/2" CAVITY WALL INSULATION
- 103-D FLASHING AND S.S. DRIP EDGE
- 103-E ROPE WEEP AT 24" O.C.
- 103-F GLAZED, BULLNOSED, CMU BASE (COVERED AT PUBLIC LOBBY TO RECEIVE TERRAZZO FLOOR SHOWN DASHED) GROUT SOLID CHARCOAL COLOR
- 103-G CONTINUOUS 4"x3 1/2"x3/8" GALVANIZED STEEL ANGLE W/ 1/2" DIA. EXPANSION ANCHOR-32" O.C.

## 104. TYPICAL MASONRY WALL CONSTRUCTION :

- 104-A FACE BRICK
- 104-B 1 1/4" AIR SPACE
- 104-C 2 1/2" CAVITY INSULATION
- 104-D NOT USED
- 104-E 8" CONCRETE MASONRY UNIT W/SELF ADHERING AIR & WATER MEMBRANE
- 104-F THROUGH WALL FLASHING AT 24" O.C. VERT. - 8" O.C. VERT. @ PARAPET TYP.

## 105. TYPICAL MASONRY WALL AT SPANDREL BEAM :

- 105-A STRUCTURAL CONCRETE DECK (BROOM FINISH AT ROOF DECK)
- 105-B STRUCTURAL GALVANIZED METAL DECK
- 105-C BENT PLATE POUR STOP
- 105-D REINFORCEMENT- NO. 4 REBAR WELDED TO POUR STOP AT 4'-0" O.C. FULL HT. OF PARAPET
- 105-E 1" COMPRESSIBLE FILLER BETWEEN SLAB AND CMU
- 105-F CONTINUOUS SHEET OF HORIZONTAL FLASHING AT JUNCTION OF FLOOR SLAB AND CMU WALL
- 105-G 6" CONCRETE MASONRY UNIT AT SPANDREL BEAM
- 105-H RECEIVER ANGLE WITH FLEXIBLE ANCHORS -16" O.C. AT SPANDREL BEAM.

## 106. TYPICAL LATERAL SUPPORT ANGLE AT MASONRY WALL AND SPANDREL BEAM :

- 106-A FIELD WELDED CLIP ANGLE: REF. STRUCT. DWGS. FOR SIZE, SPACING & EXPANSION ANCHORS
- 106-B OPEN
- 106-C OPEN
- 106-D CONT. CMU BOND BEAM W/2 NO.4 REBARS

## 107. TYPICAL ROOF ASSEMBLY :

- 107-A 2"x2" THICK CONC. PAVERS
- 107-B 6" ROOF INSULATION, 3" AT COMMUNITY ROOM
- 107-C FLEXIBLE ROOF MEMBRANE ASSEMBLY
- 107-D SLOPED STRUCTURAL CONCRETE ROOF DECK-BROOM FINISH
- 107-E 80 MIL ASPH/FLT BASE SHEET (SHOWN DASHED)
- 107-F STRUCTURAL GALVANIZED METAL DECK
- 107-G PROTECTIVE FLASHING & ROOFING MEMBRANE ON VERTICAL SURFACE AT PARAPET, RUN ROOF FLASHING MEMBRANE UNDER STONE OR ALUM COPING
- 107-H TWO WYTHES OF BRICK WITH GROUT REINF. CAVITY AT PARAPET.
- 107-I ROOF CONCRETE PAVERS
- 107-J SEALANT

## 108. TYPICAL LIMESTONE SILL AT ALUM WINDOW :

- 108-A CASEMENT ALUM WINDOW
- 108-B 1" INSULATED, TINTED GLAZING
- 108-C 3/8" SEALANT, JOINT AND BACKER ROD BOTH SIDES
- 108-D PVC CAULK BACKER AND SHIM
- 108-E LIMESTONE SILL W/ DRIP
- 108-F THROUGH WALL FLASHING W/S W/ S.S. DRIP EDGE
- 108-G ROPE WEEPS AT 24" O.C.
- 108-H OPEN
- 108-I BULLNOSED, GLAZED CMU SILL GROUT SOLID-EGGSHELL COLOR
- 108-J 4"x3 1/2"x3/8" GALVANIZED, CONTINUOUS ANGLE AT WINDOW OPENING W/ 1/2" EXPANSION ANCHOR -24" O.C.
- 108-K 3/8" THK x 4" WIDE CONTINUOUS GALV. STEEL PLATE
- 108-L SOLID GLASS BLOCK (BREAK ROOM)
- 108-M FIXED ALUM WINDOW
- 108-N BULLNOSED, GLAZED CMU SILL GROUT SOLID-CHARCOAL COLOR

## 109. TYPICAL LINTEL AT ALUM WINDOW / ARCHITECTURAL LOUVER :

- 109-A 5/8" SEALANT JOINT AND BACKER ROD BOTH SIDES
- 109-B PVC CAULK BACKER
- 109-C PRECAST LINTEL W/ DRIP EDGE-REF. STRUCT LINTEL SCHEDULE
- 109-D FOAM FILLED INSULATION - 2" NOMINAL THICKNESS
- 109-E 2"x3/8" GALVANIZED, CONTINUOUS ANGLE AT WINDOW OPENING W/ 1/2" EXPANSION ANCHOR -24" O.C.
- 109-F THROUGH WALL FLASHING W/S.S. DRIP EDGE
- 109-G WEEP HOLE VENTILATOR - 2" O.C.
- 109-H 3-1/2" x 4" x 3/8" GALV. CONTINUOUS ANGLE AT OPENING W/ 1/2" EXPANSION ANCHOR-24" O.C.
- 109-I GALVANIZED STEEL LINTEL-REF. STRUCT LINTEL SCHEDULE

## 110. TYPICAL LIMESTONE COPING :

- 110-A STONE COPING
- 110-B SET STONE COPING ON MORTAR BED ON FLASHING W/ S.S. DRIP EDGE
- 110-C OVER ROOF FLASHING MEMBRANE, BACKER ROD AND SEALANT ONLY, BETWEEN LIMESTONE COPING VERTICAL JOINTS
- 110-D CONTINUOUS FRICTION FIT CAVITY INSULATION AT CAVITY SUPPORTING ROOF FLASHING MEMBRANE
- 110-E 3/8" DIA. STAINLESS STEEL DONUT W/ 3/8" DIA. STAINLESS STEEL ANCHOR WITH HOOK AT EACH JOINT AND GROUT SOLID AT CMU SEAL FLASHING AT ALL PENETRATIONS
- 110-F BOND BEAM W/ 2 NO. 4 BARS

## 111. TYPICAL ALUM COPING :

- 111-A PREFINISHED ALUM COPING SYSTEM-063 THK
- 111-B CONT. GALVANIZED 1/2" THICK STEEL ANCHOR PLATE
- 111-C SPLICE PLATE SHOWN DASHED
- 111-D RUN ROOF FLASHING MEMBRANE UNDER ANCHOR PLATE
- 111-E TWO LAYERS OF 3/4" EXT. FIRE TREATED PLYWOOD W/ SEALER GLUED TOGETHER AND EXP. ANCHORED WITH 1/2" ANCHORS @ 24" O.C. INTO TOP OF WALL
- 111-F REINFORCING AND CANTILEVERED OVER VENEER WYTHE
- 111-G 1" RETURN FOR SEALANT AND BACKER ROD

## 112. ALUM FASCIA :

- 112-A COMPOSITE METAL PANEL & COPING SYSTEM
- 112-B ALUMINUM EXTRUSION ASSEMBLY FOR ATTACHMENT OF METAL COPING
- 112-C CONTINUOUS HORIZONTAL FLASHING SHOWN DASHED
- 112-D EXTERIOR SHEATHING- 1/2" GLASS MAT GYP. BD.
- 112-E COLD FORMED METAL FRAMING-3-5/8" PUBLIC LOBBY, 2-1/2" AT COMMUNITY ROOM, 16GA, 16" O.C.
- 112-F COLD FORMED METAL FRAMING BRACING-3-5/8", 16GA, 32" O.C. (PUBLIC LOBBY ONLY)
- 112-G BACKER ROD AND SEALANT AT ALL 1/2" JOINTS
- 112-H MOUNTING CHANNEL FOR DRAINAGE & AIR BAFFLE
- 112-I ALUM. ANGLE & SHIMS, PROVIDE ISOLATION @ STRUCTURE

## 113. GUARD RAIL ASSEMBLY :

- 113-A STEEL PIPE GUARD RAIL-1-1/4" I.D. TOP W/ 1"x1-1/2" STL. BAR UPRIGHTS
- 113-B 3/4" DIA. SOLID ROD HORIZ. (8 EQ. SPACES-PASS THRU UPRIGHTS)
- 113-C STAINLESS STEEL HANDRAIL-1-1/4" I.D.
- 113-D STEEL ROD HANDRAIL SUPPORT-1-1/2" DIA. SUPPORT ON 1/4" PLATE OFF UPRIGHTS

## 114. FIRESTOPPING (COLOR BLACK) :

- 2" FIRESPAN 90-FOIL FACED BETWEEN VERTICAL MULLION
- 1" FIRESPAN 90x140" WIDE OVER VERTICAL MULLION
- 4" FOIL FACED SAFFIN INSULATION FROM CURTAIN WALL TO SLAB, FIRESTOP CAULK FOIL FACED JOINTS AT FLOOR SLAB

## 115. MASONRY PARAPET AT ALUM FASCIA :

- 115-A KERFED TREATED 2X W/ 1/2" DIA. ANCHOR BOLT - 24" O.C.
- 115-B 8" CONCRETE MASONRY UNIT, GROUT SOLID

## 116. TYPICAL PLASTER SOFFIT :

- 116-A SUSPENDED 1" METAL LATH AND CEMENT PLASTER
- 116-B FURRING CHANNELS-3/4", 12" O.C.
- 116-C COLD ROLLED CHANNELS-1-1/2", 40" O.C.
- 116-D CONTINUOUS SOFFIT VENT BY FRY-REGLET, FRY FP-75-V OR EQUAL

## 117. THERMAL BARRIER WALL ASSEMBLY AT CURTAIN WALL :

- 117-A SELF ADHERING AIR & WATER MEMBRANE
- 117-B EXTERIOR SHEATHING-1/2"
- 117-C COLD FORMED METAL FRAMING-3-3/8", 16GA, 16" O.C.
- 117-D SEMI RIGID FIBERGLASS INSULATION-3-1/2"
- 117-E VAPOR RETARDER
- 117-F SPAN DECK FLUTES W/ CONTINUOUS SHEET METAL PLATE-FILL FLUTES SOLID W/ INSULATION
- 117-G CONTINUOUS 5/8"x3/8" ANGLE, LONG VERT. LEG CLIPPED AT PERPENDICULAR BEAMS - PUBLIC LOBBY ONLY
- 117-H CONTINUOUS 6/8" THK STEEL PLATE-COMMUNITY ROOM ONLY

## 118. ALUM CURTAIN WALL :

- 118-A ALUM CURTAIN WALL
- 118-B 1" INSULATED CLEAR GLAZING
- 118-C ALUM ANGLE AT INTERSECTION OF CEILING
- 118-D PVC CAULK BACKER AND SHIM AT HEAD, SILL AND JAMB CONDITIONS
- 118-E 3/4" SEALANT JOINT AND BACKER ROD AT HEAD AND SILL, 1/2" AT JAMB
- 118-F EXTRUDED ALUM SILL EXTENSION AT SILL, PROVIDE 1" RETURN AT JAMB FOR BACKER ROD AND SEALANT
- 118-G ALUM BUTT GLAZED CORNER SPACER
- 118-H STRUCTURAL ATTACHMENT - STL. CLIP ANGLES BY CURTAIN WALL MANUFACTURER
- 118-I 1" INSULATED TINTED GLAZING
- 118-J 1" INSULATED SPANDREL GLAZING

## 119. SUSPENDED GYPSUM BOARD CEILING :

- 119-A GYPSUM BOARD CEILING-5/8"
- 119-B HAT CHANNELS-7/8", 16" O.C.
- 119-C COLD FORMED CHANNELS-1-1/2", 40" O.C.
- 119-D 1/2" METAL REVEAL (PAINT)

## 120. WOOD PANEL WALL ASSEMBLY :

- 120-A GYPSUM BOARD-5/8"
- 120-B 6" MTL FRAMING-16GA, 16" O.C.
- 120-C SOUND ATTENUATION BLANKET
- 120-D AIR GAP-1/2"
- 120-E WOOD VENEER PANEL W/ CLEATS
- 120-F CONTINUOUS SHEET METAL BLOCKING
- 120-G 1/2" HARD WOOD EDGE

## 121. FLASHING AT ROOF AND MASONRY WALL :

- 121-A 8" CONCRETE MASONRY UNIT
- 121-B WEEP HOLE VENTILATOR-2" O.C.
- 121-C PLANT FLOOR INSULATION
- 121-D THROUGH WALL FLASHING W/ S.S. DRIP EDGE
- 121-E PREFINISHED METAL FLASHING W/ FASTENERS AND NEOPRENE WASHERS- 24" O.C.
- 121-F RUN ROOF FLASHING MEMBRANE UNDER MTL. FLASHING

## 122. CANOPY AT PUBLIC LOBBY :

- 122-A SEALANT JOINT AND BACKER ROD BOTH SIDES
- 122-B 2-PIECE-1/8" THK ALUM CLOSURE - PROVIDE 1" LIP RETURN AT JAMB FOR BACKER ROD AND SEALANT
- 122-C SEMI-RIGID INSULATION
- 122-D STEEL TUBE FRAMING REF. STRUCT.
- 122-E EXPOSED PAINTED STEEL FRAME W/ HIGH GLOSS FINISH, W/TER WELD & GRIND SMOOTH ALL CORNERS REF. STRUCTURAL.
- 122-G ALUMINUM REVOLVING DOOR

## 123. LINTEL AND JAMB AT OVERHEAD DOOR :

- 123-A PRECAST LINTEL-REF. STRUCT LINTEL SCHEDULE
- 123-B THROUGH WALL FLASHING W/ S.S. DRIP EDGE
- 123-C OPEN
- 123-D CLIP ANGLE TO SPANDREL BEAM, - REF. STRUCT.
- 123-E HI-SPEED INSULATED MOTORIZED OVERHEAD ALUM. COILING SALLY PORT DOORS
- 123-F REINFORCED NORTH / SOUTH MASONRY WALLS AT SALLY PORT W/ NO. 4 REBAR @ O.C.
- 123-G CONTINUOUS 4"x6"x3/8" S.S. STEEL ANGLE TO B/ LINTEL W/ MASONRY ANCHOR 16" O.C. & 3/8" DIA. HEAD STUD BOLTS 16" O.C.
- 123-H OPEN
- 123-I ALUM SECTIONAL OVERHEAD DOOR

## 124. TYPICAL JAMB AT ALUM WINDOW :

- 124-A FIXED ALUM WINDOW
- 124-B OPEN
- 124-C 1/2" SEALANT JOINT AND BACKER ROD BOTH SIDES
- 124-D PVC CAULK BACKER AND SHIM
- 124-E GALVANIZED 2"x3/8" ANGLE W/ 1/2" DIA EXPANSION ANCHOR-24" O.C.
- 124-F GROUT CMU SOLID AT JAMB

## 125. ALUM DETENTION WINDOW :

- 125-A ALUM DETENTION WINDOW W/ SECURITY GLAZING

## 126. TYPICAL GYPSUM BOARD SOFFIT / LIGHT COVE :

- 126-A 5/8" GYP. BD. OVER 3-3/8" METAL FRAMING-16" O.C.
- 126-B METAL FRAMING BRACING-32" O.C.
- 126-C FLUORESCENT LIGHTING FIXTURES-STAGGERED
- 126-D PAINTED PL WOOD PLATFORM
- 126-E SPAN DECK FLUTES W/ CONTINUOUS METAL SHEET PLATE
- 126-F HARDWOOD FASCIA AT PUBLIC LOBBY
- 126-G 2"-18 GA 1/2" CLIP-24" O.C. WELD TO BEAM BEFORE SPRAY FIREPROOF

## 127. MASONRY MISC. :

- 127-A 4" CONCRETE MASONRY UNIT W/ SELF ADHERING AIR & WATER MEMBRANE
- 127-B 6" CONCRETE MASONRY UNIT W/ SELF ADHERING AIR & WATER MEMBRANE
- 127-C 8" CONCRETE MASONRY UNIT W/ SELF ADHERING AIR & WATER MEMBRANE
- 127-D SELF-ORIENTING W/ FLEXIBLE ANCHORS-16" O.C.
- 127-E BASKET-WEAVED BRICK PATTERN
- 127-F GROUND FACE FINISH CMU
- 127-G SPECIAL LIMESTONE SHAPES ONE EACH COURSE
- 127-H MASONRY EXPANSION JOINT-BACKER ROD & SEALANT
- 127-I COMPRESSIBLE FILLER
- 127-J CONTINUOUS SHEET OF FLASHING OVER JOINT
- 127-K STONE ASHLAR, SMOOTH FINISH-15-3/8"x15-3/8"x24"
- 127-L 2-3/8" THK STONE PANEL-BACKER ROD AND SEALANT EACH JOINT- PROVIDE 3" WIDE 12 GA S.S. SPLIT END ANCHOR
- 127-M FLEXIBLE ANCHOR- 16" O.C.
- 127-N CMU CONTROL JOINT SEE 3.4.5.1A9.1

## 128. COLUMN COVER ASSEMBLY :


- 128-A COMPOSITE METAL PANEL SYSTEM
- 128-B ALUMINUM MOUNTING ANGLE & SHIMS, PROVIDE ISOLATION AT STRUCTURE SEPARATION POINTS
- 128-C SELF ADHERING AIR & WATER MEMBRANE
- 128-D THROUGH WALL FLASHING W/ S.S. DRIP EDGE
- 128-E GALVANIZED COLD FORMED METAL FRAMING-8", 16 GA. AT 16" O.C. MAX.
- 128-F PANEL JOINT FOR SEALANT AND BACKER ROD-1/2"
- 128-G CONTINUOUS TREATED 2x BLOCKING BETWEEN PANEL JOINT AT COLUMN COVER TO RECEIVE MOVABLE PARTITION AT COLUMN LINE E.2.8.3 ONLY
- 128-H MOVABLE PARTITION
- 128-I 3" WIDE 12 GA. S.S. SPLIT END ANCHOR
- 128-L MOUNTING CHANNEL FOR DRAINAGE & AIR BAFFLE

## 129. ALUM DOOR AT THRESHOLD :

- 129-A ALUM THRESHOLD 7" WIDE
- 129-B 2"x2-3/8" GALV. ANGLE W/ ANCHORS AT 24" O.C.
- 129-C ALUM DOOR W/ 1" INSULATED TINTED GLAZING

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	<b>DESCRIPTION:</b> UPDATED NOTES LEGEND	<b>REVISION:</b> ISSUED FOR ADDENDUM 2	<b>DATE:</b> 07/02/2010	<b>CHECKED BY:</b> KMC	<b>REFERENCE:</b> A5.1-6.14

9.2

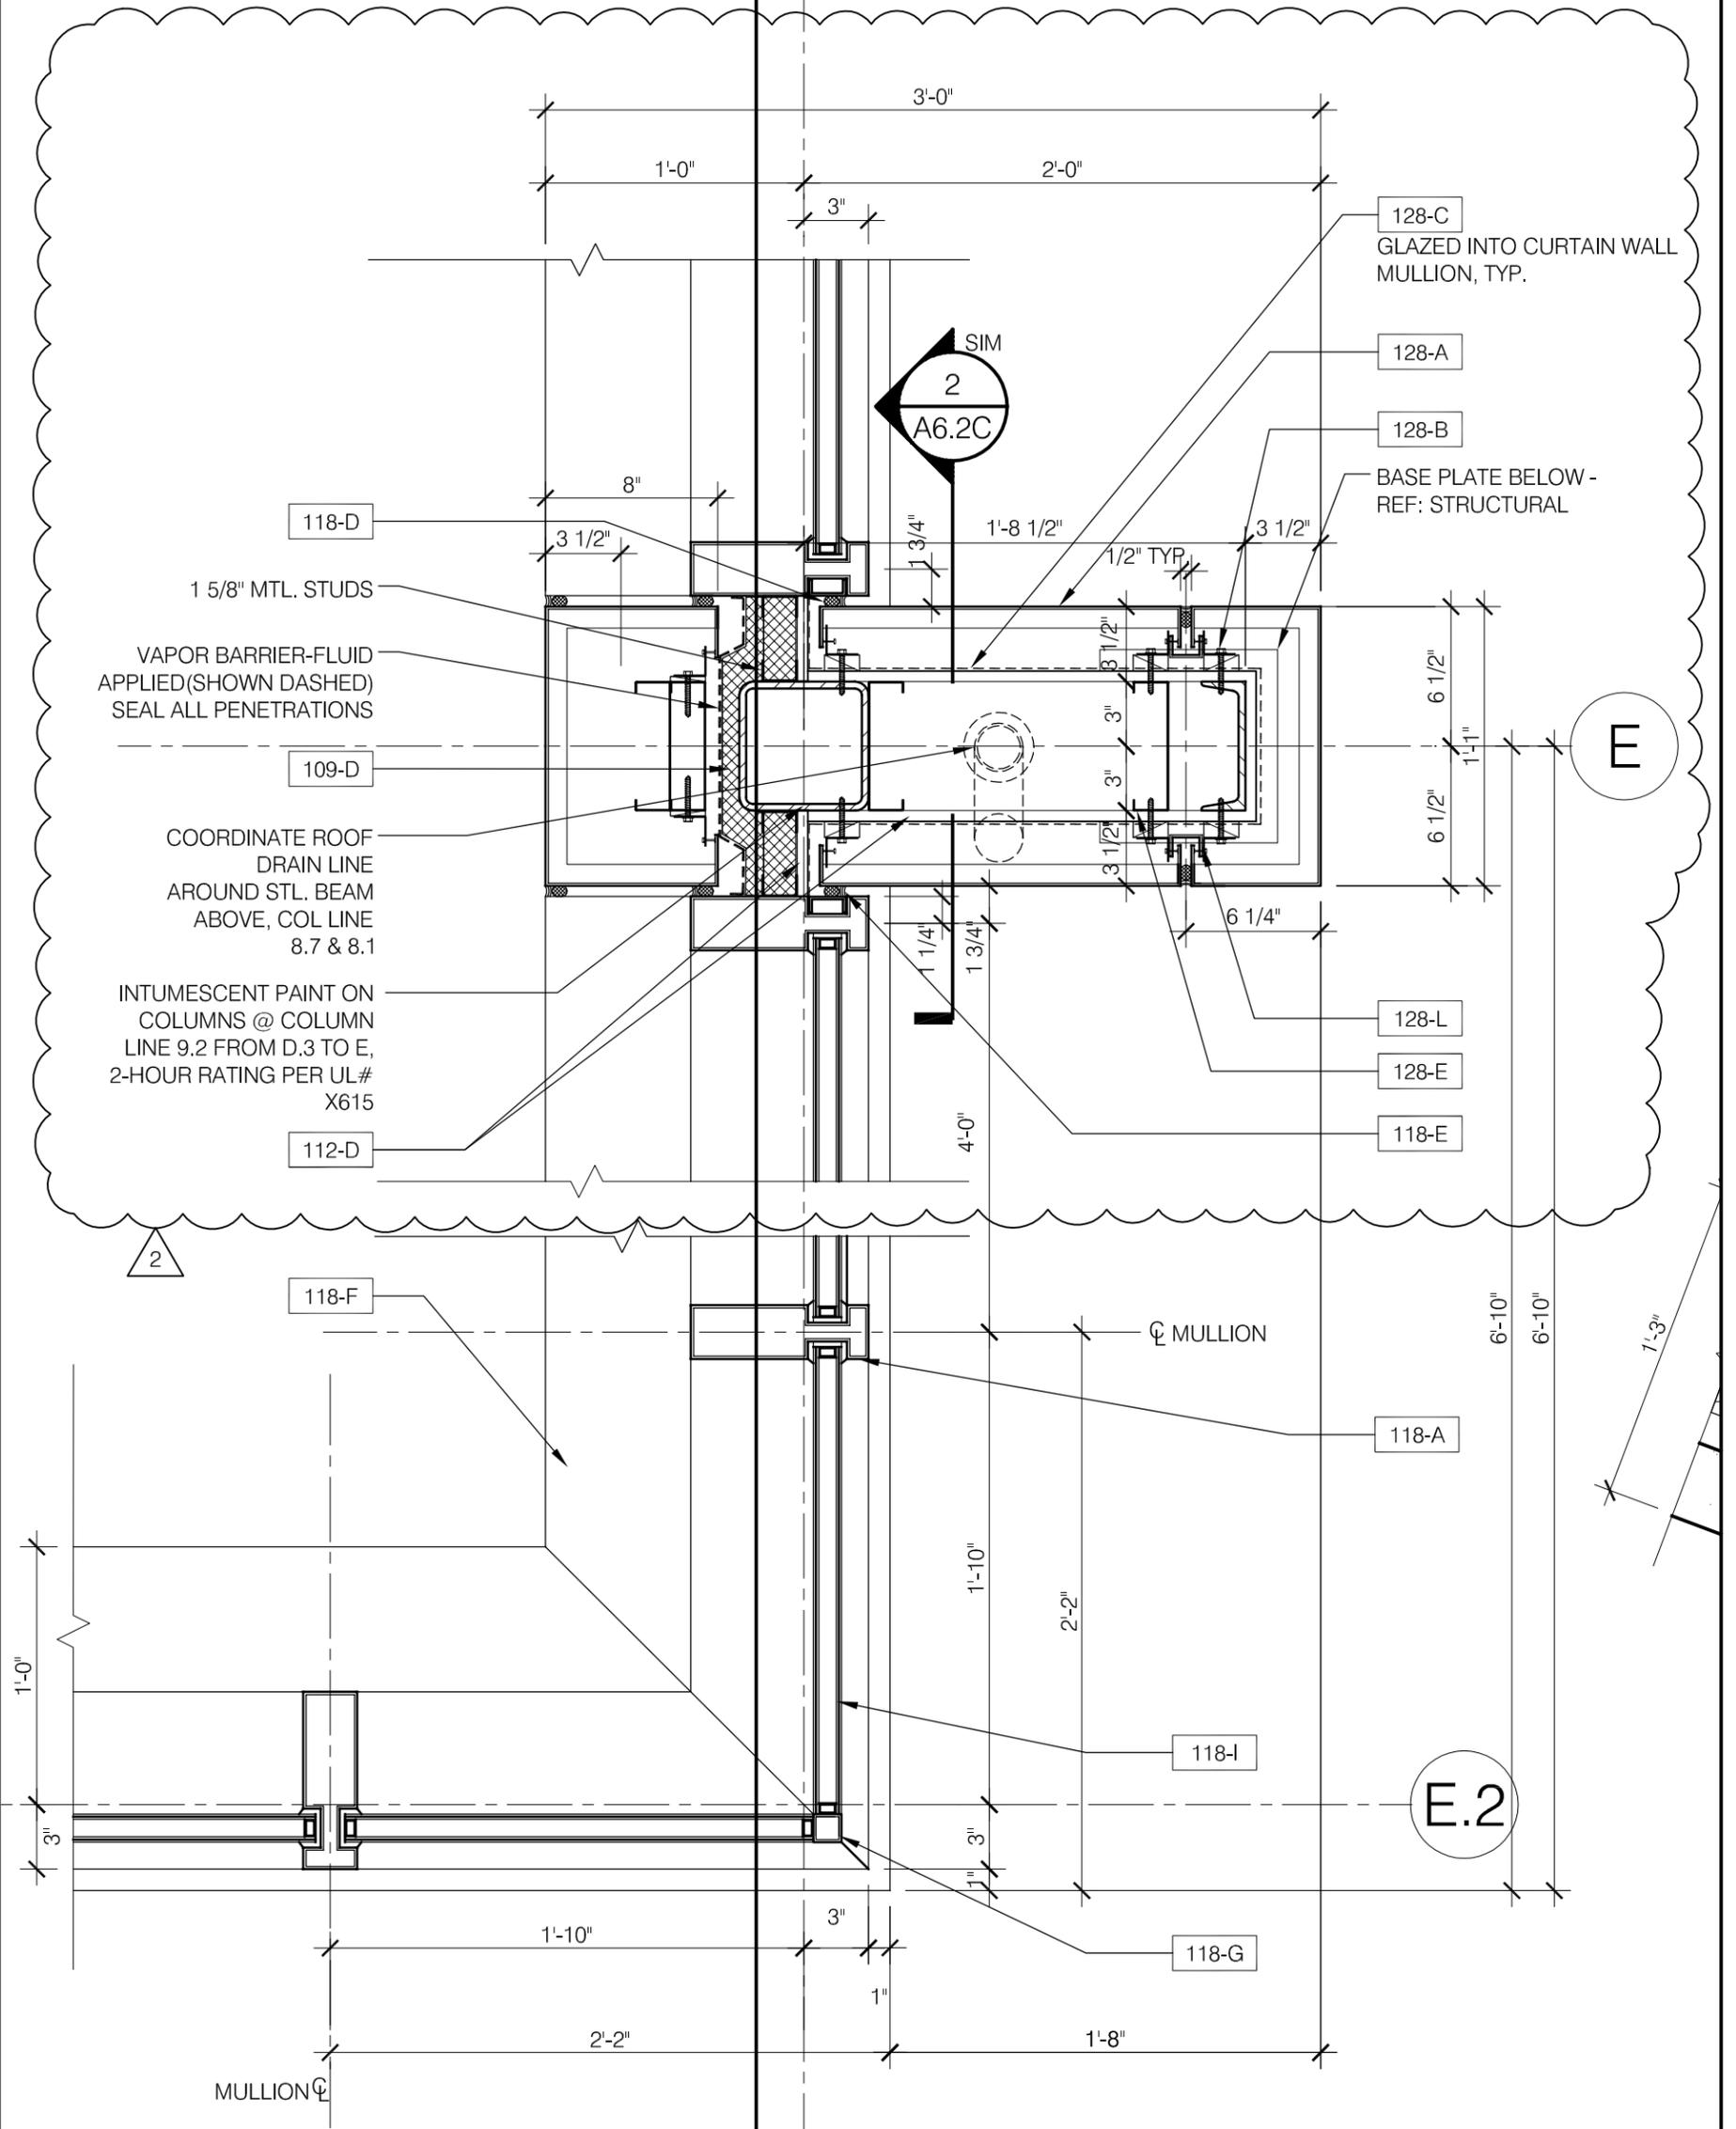


2 PLAN DETAIL @ COMMUNITY ROOM  
 A6.1 1 1/2" = 1'-0"

FILE: U:\2443h-00 12th District Police Station\Drawings\Sheets\ASKs\ASK26.dwg  
 Plot Date: 10/17/2008

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	DESCRIPTION: UPDATED PLAN DETAIL	REVISION: ISSUED FOR ADDENDUM 2	DATE: 07/02/2010	CHECKED BY: KMC	REFERENCE: 2/A6.1


FILE: U:\2443h-00 12th District Police Station\Drawings\Sheets\ASKs\ASK27.dwg  
 Plot Date: 10/17/2008

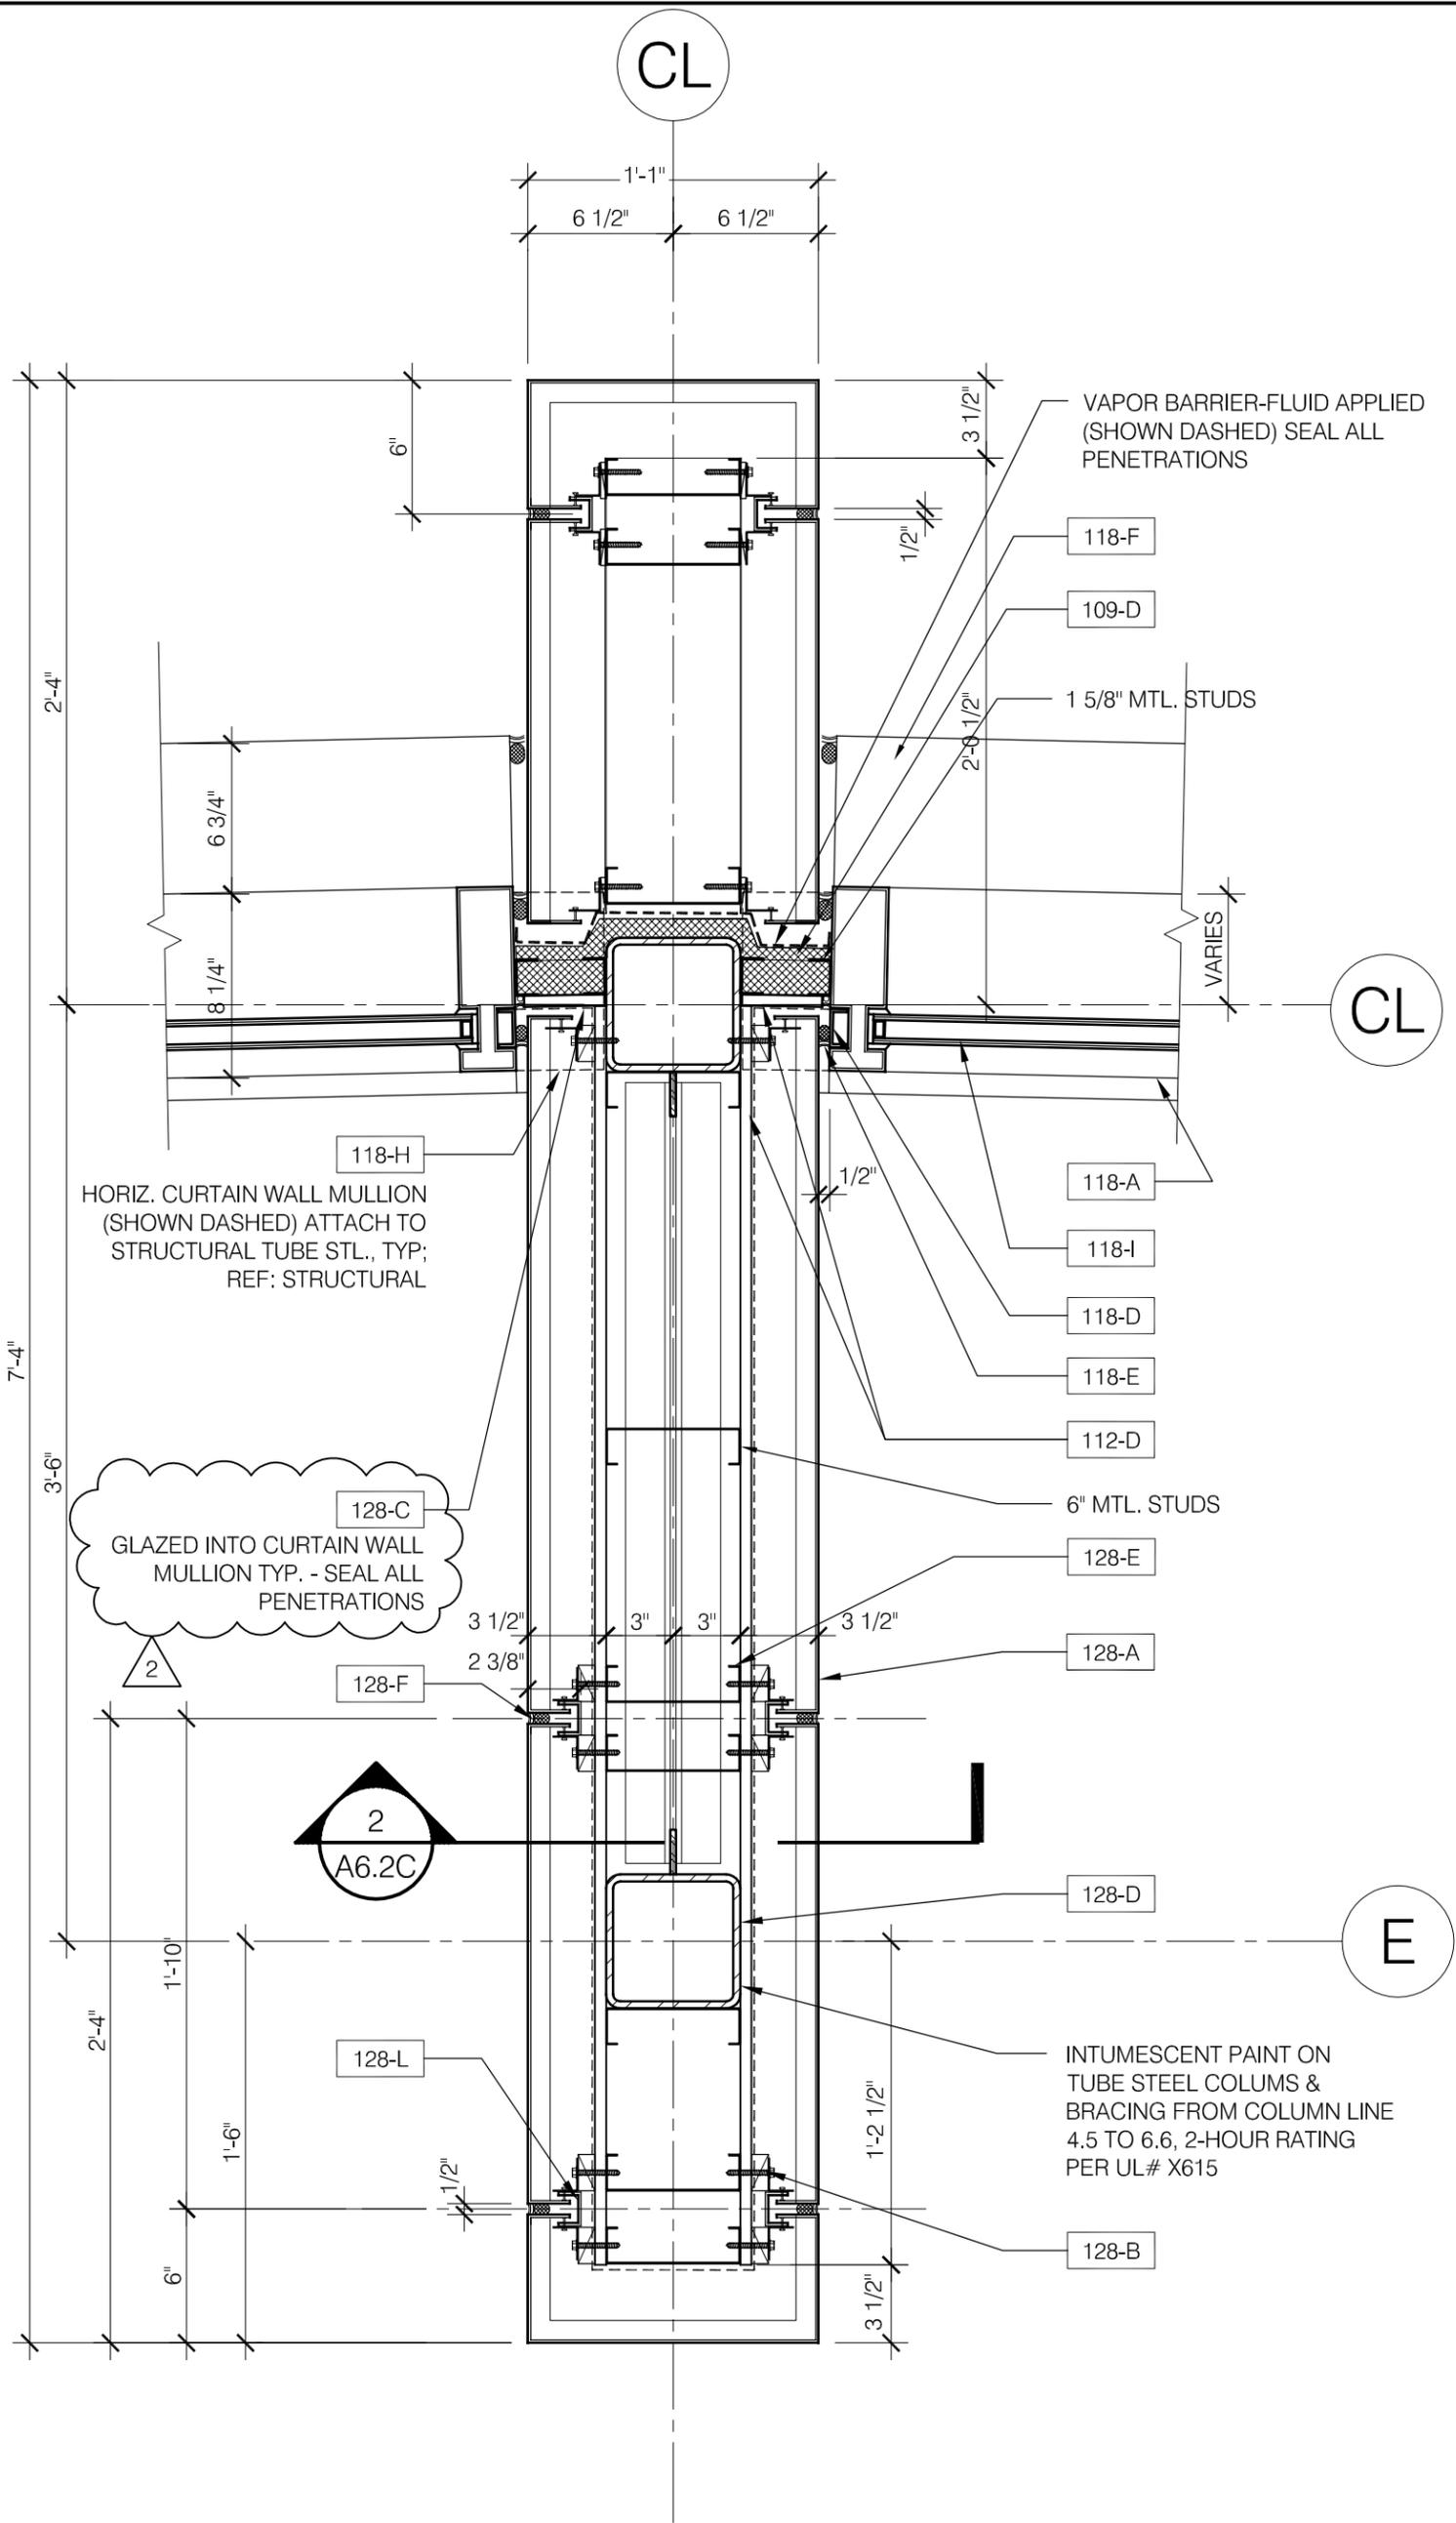

**6** PLAN DETAIL @ PUBLIC LOBBY  
 A6.1 1 1/2" = 1'-0"

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	DESCRIPTION: UPDATED PLAN DETAIL	REVISION: ISSUED FOR ADDENDUM 2	DATE: 07/02/2010	CHECKED BY: KMC	REFERENCE: <b>6/A6.1</b>


FILE: U:\2443h-00 12th District Police Station\Drawings\Sheets\ASKs\ASK28.dwg  
 Plot Date: 10/17/2008

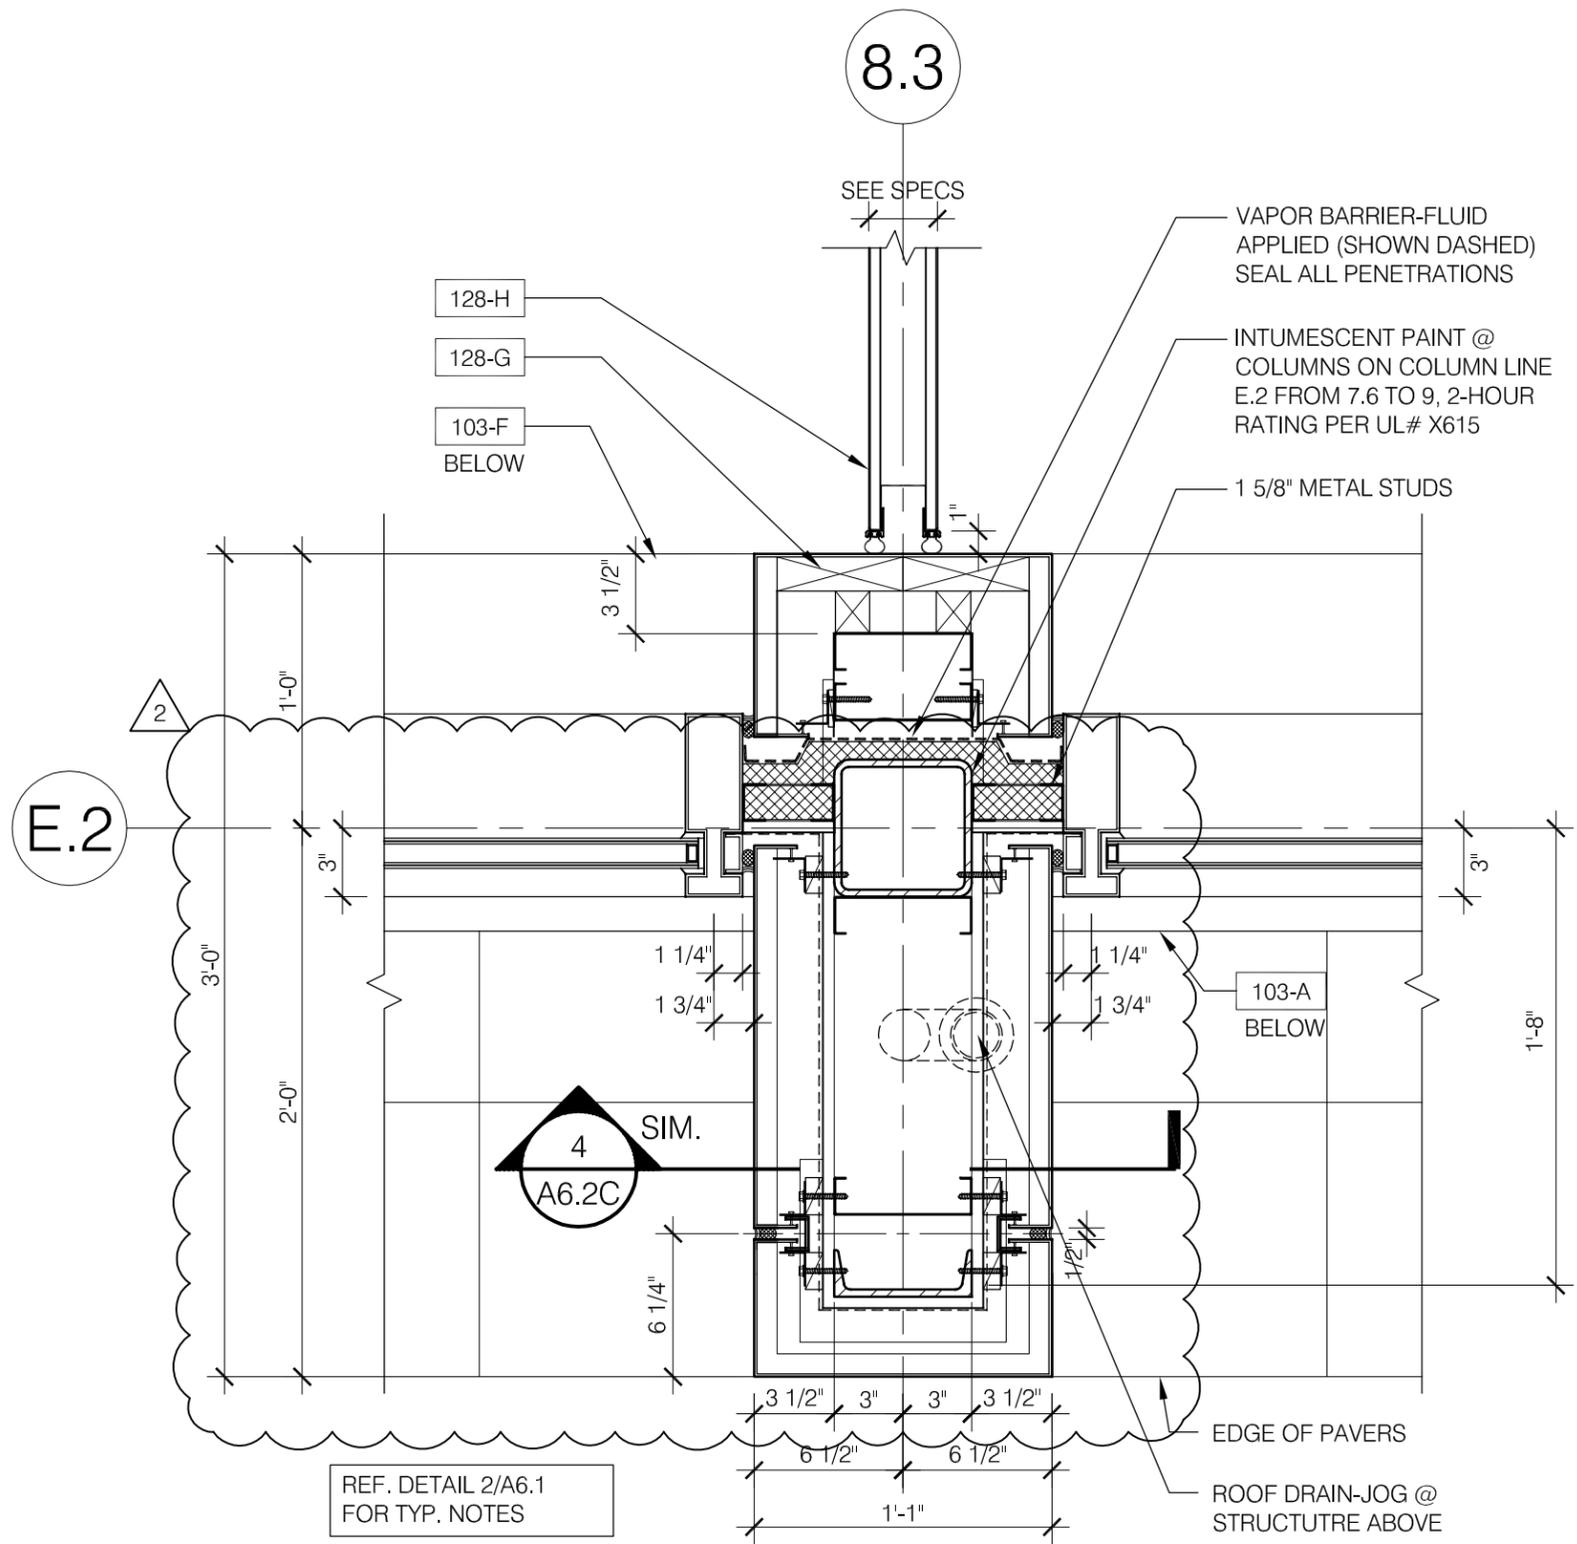

**6 PLAN DETAIL @ COMMUNITY ROOM**  
 A6.2A 1 1/2" = 1'-0"

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	DESCRIPTION: UPDATED PLAN DETAIL	REVISION: ISSUED FOR ADDENDUM 2	DATE: 07/02/2010	CHECKED BY: KMC	REFERENCE: <b>6/A6.2A</b>

6.2

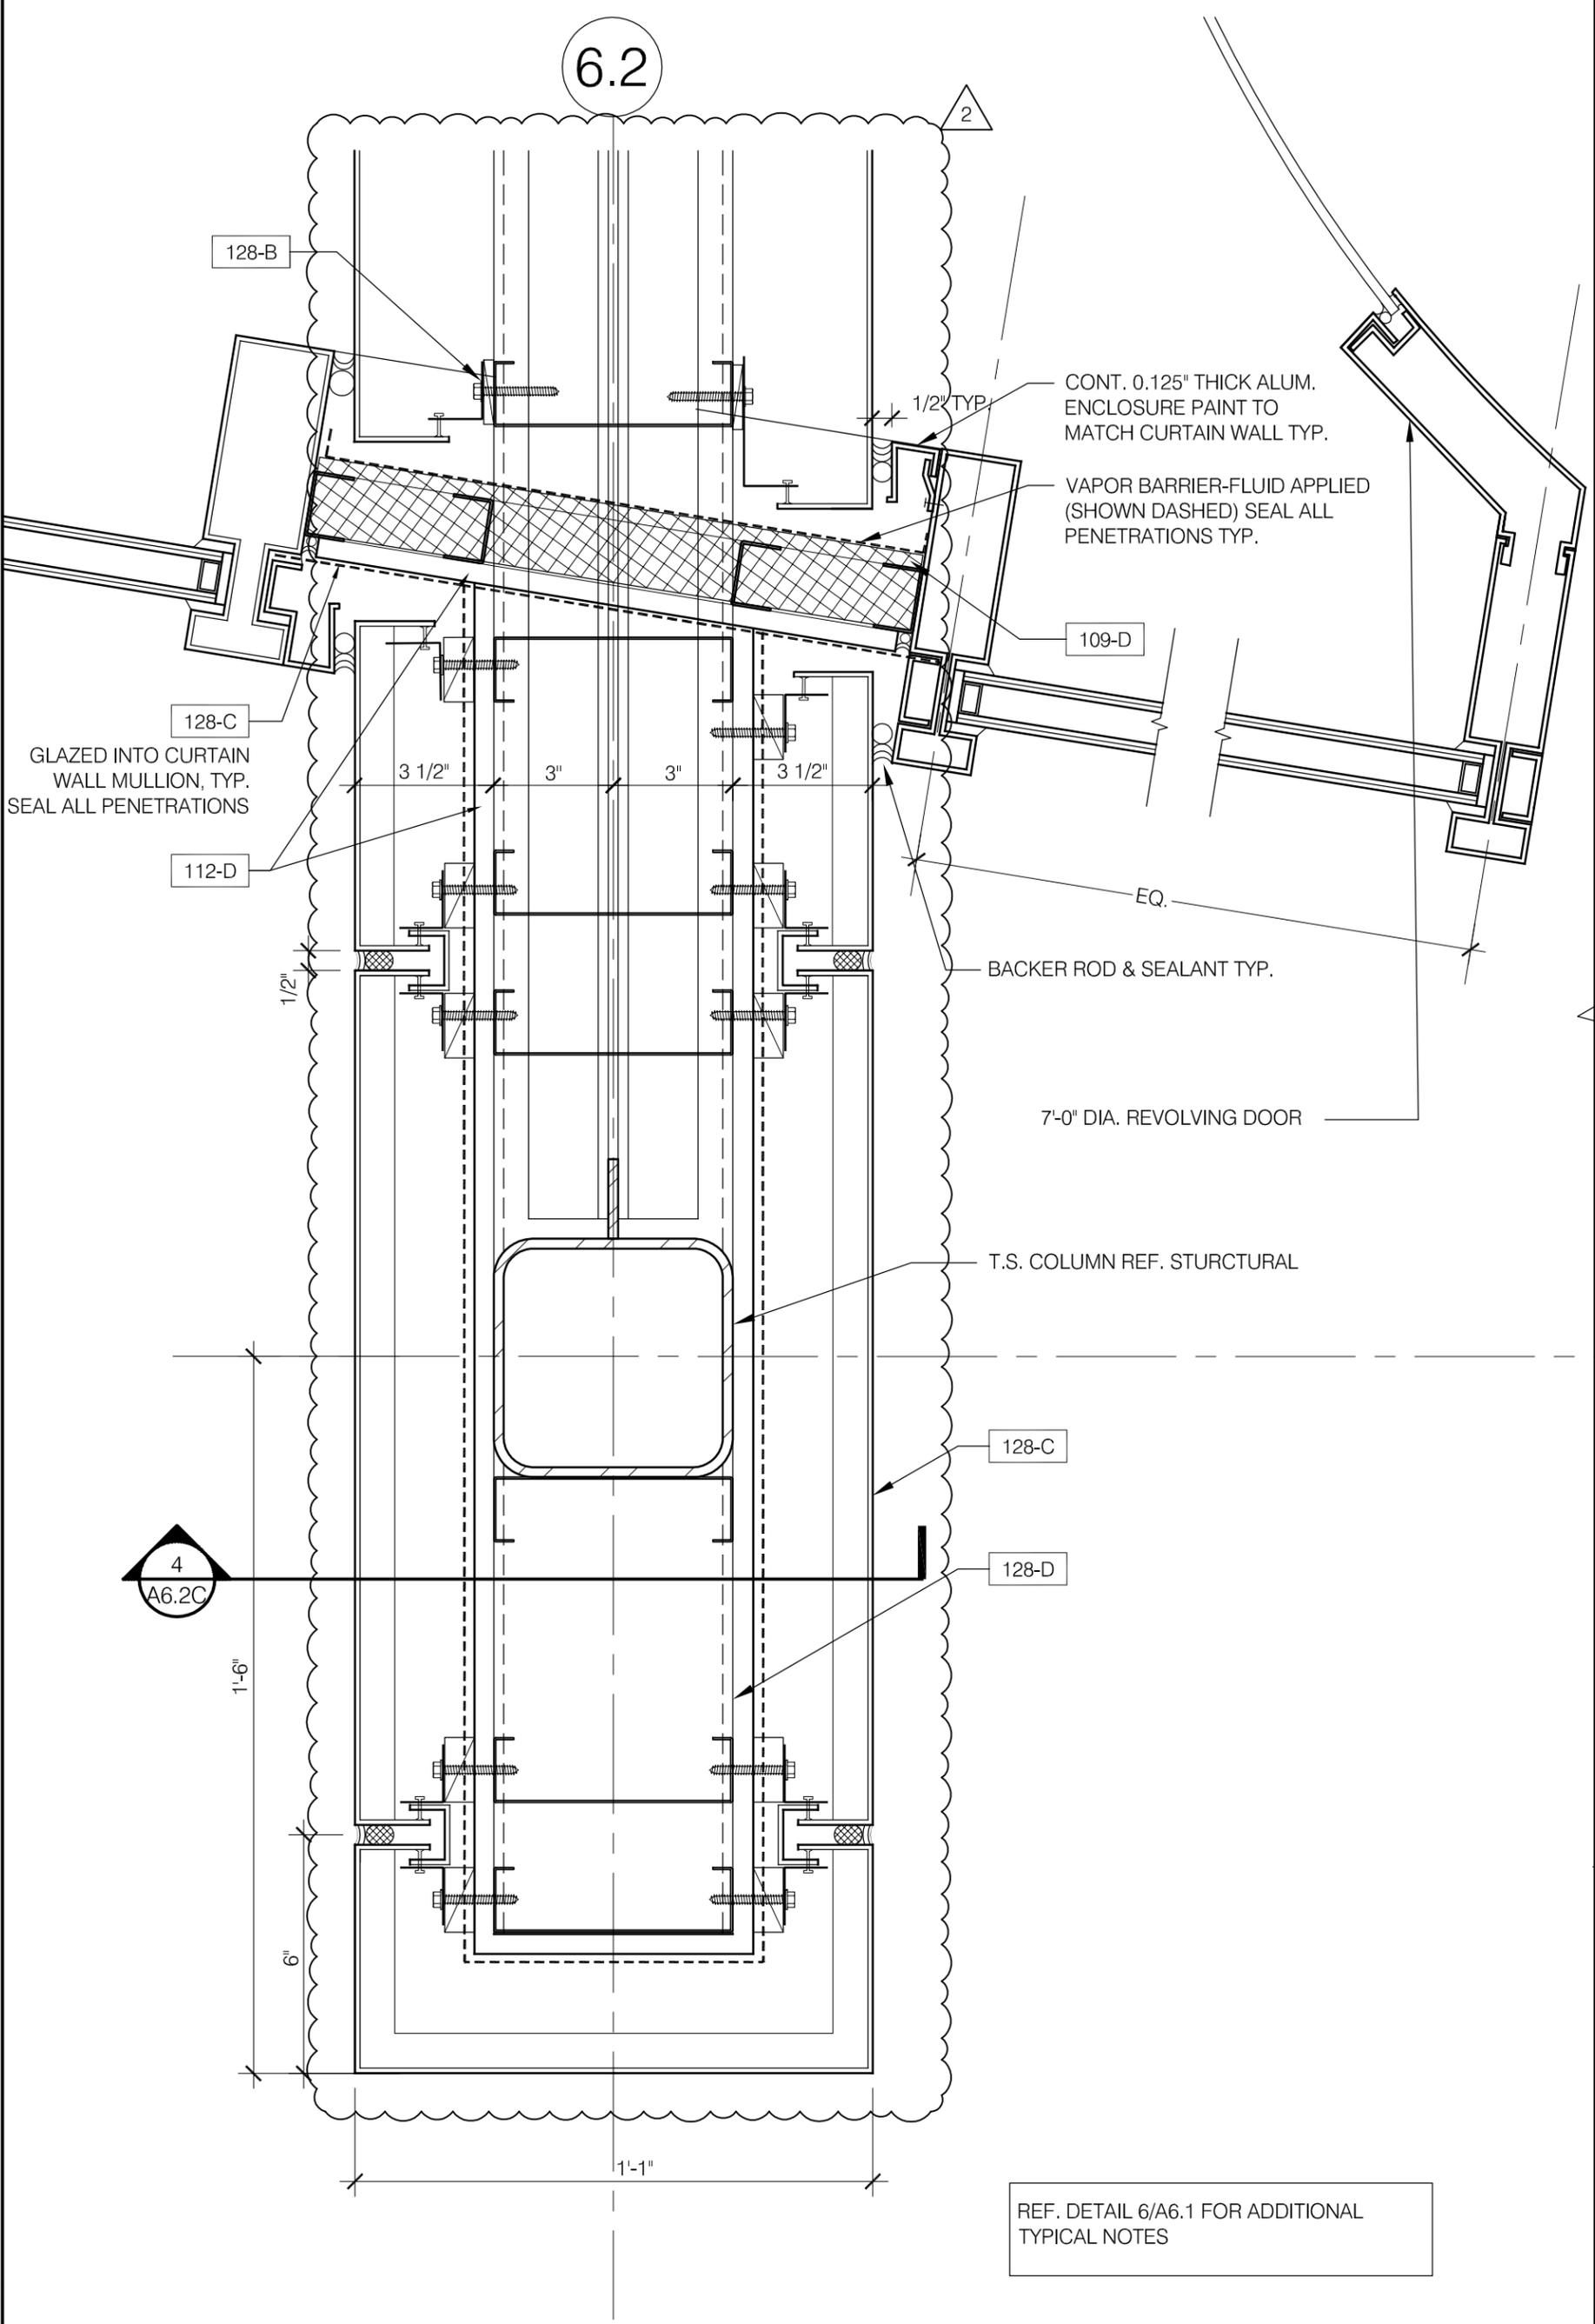

128-C  
GLAZED INTO CURTAIN WALL MULLION, TYP. SEAL ALL PENETRATIONS

CONT. 0.125" THICK ALUM. ENCLOSURE PAINT TO MATCH CURTAIN WALL TYP.

VAPOR BARRIER-FLUID APPLIED (SHOWN DASHED) SEAL ALL PENETRATIONS TYP.

BACKER ROD & SEALANT TYP.

7'-0" DIA. REVOLVING DOOR

T.S. COLUMN REF. STRUCTURAL

128-C

128-D

REF. DETAIL 6/A6.1 FOR ADDITIONAL TYPICAL NOTES

4  
A6.2C

1'-6"

6"

1'-1"

1/2"

3 1/2"

3"

3"

3 1/2"

2

FILE: U:\2443h-00 12th District Police Station\Drawings\Sheets\ASKs\ASK29.dwg  
Plot Date: 10/17/2008



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**PUBLIC BUILDING COMMISSION OF CHICAGO**  
50 WEST WASHINGTON STREET  
CHICAGO, IL 60602  
DESCRIPTION:  
UPDATED PLAN DETAIL


**12th DISTRICT POLICE STATION**  
1412 SOUTH BLUE ISLAND AVENUE  
CHICAGO, IL 60608  
REVISION:  
ISSUED FOR ADDENDUM 2

SCALE:  
3"=1'-0"  
DATE:  
07/02/2010

DRAWN BY:  
LJH  
CHECKED BY:  
KMC

SHEET:  
**ASK.29**  
REFERENCE:  
**2/A6.2C**

6.6

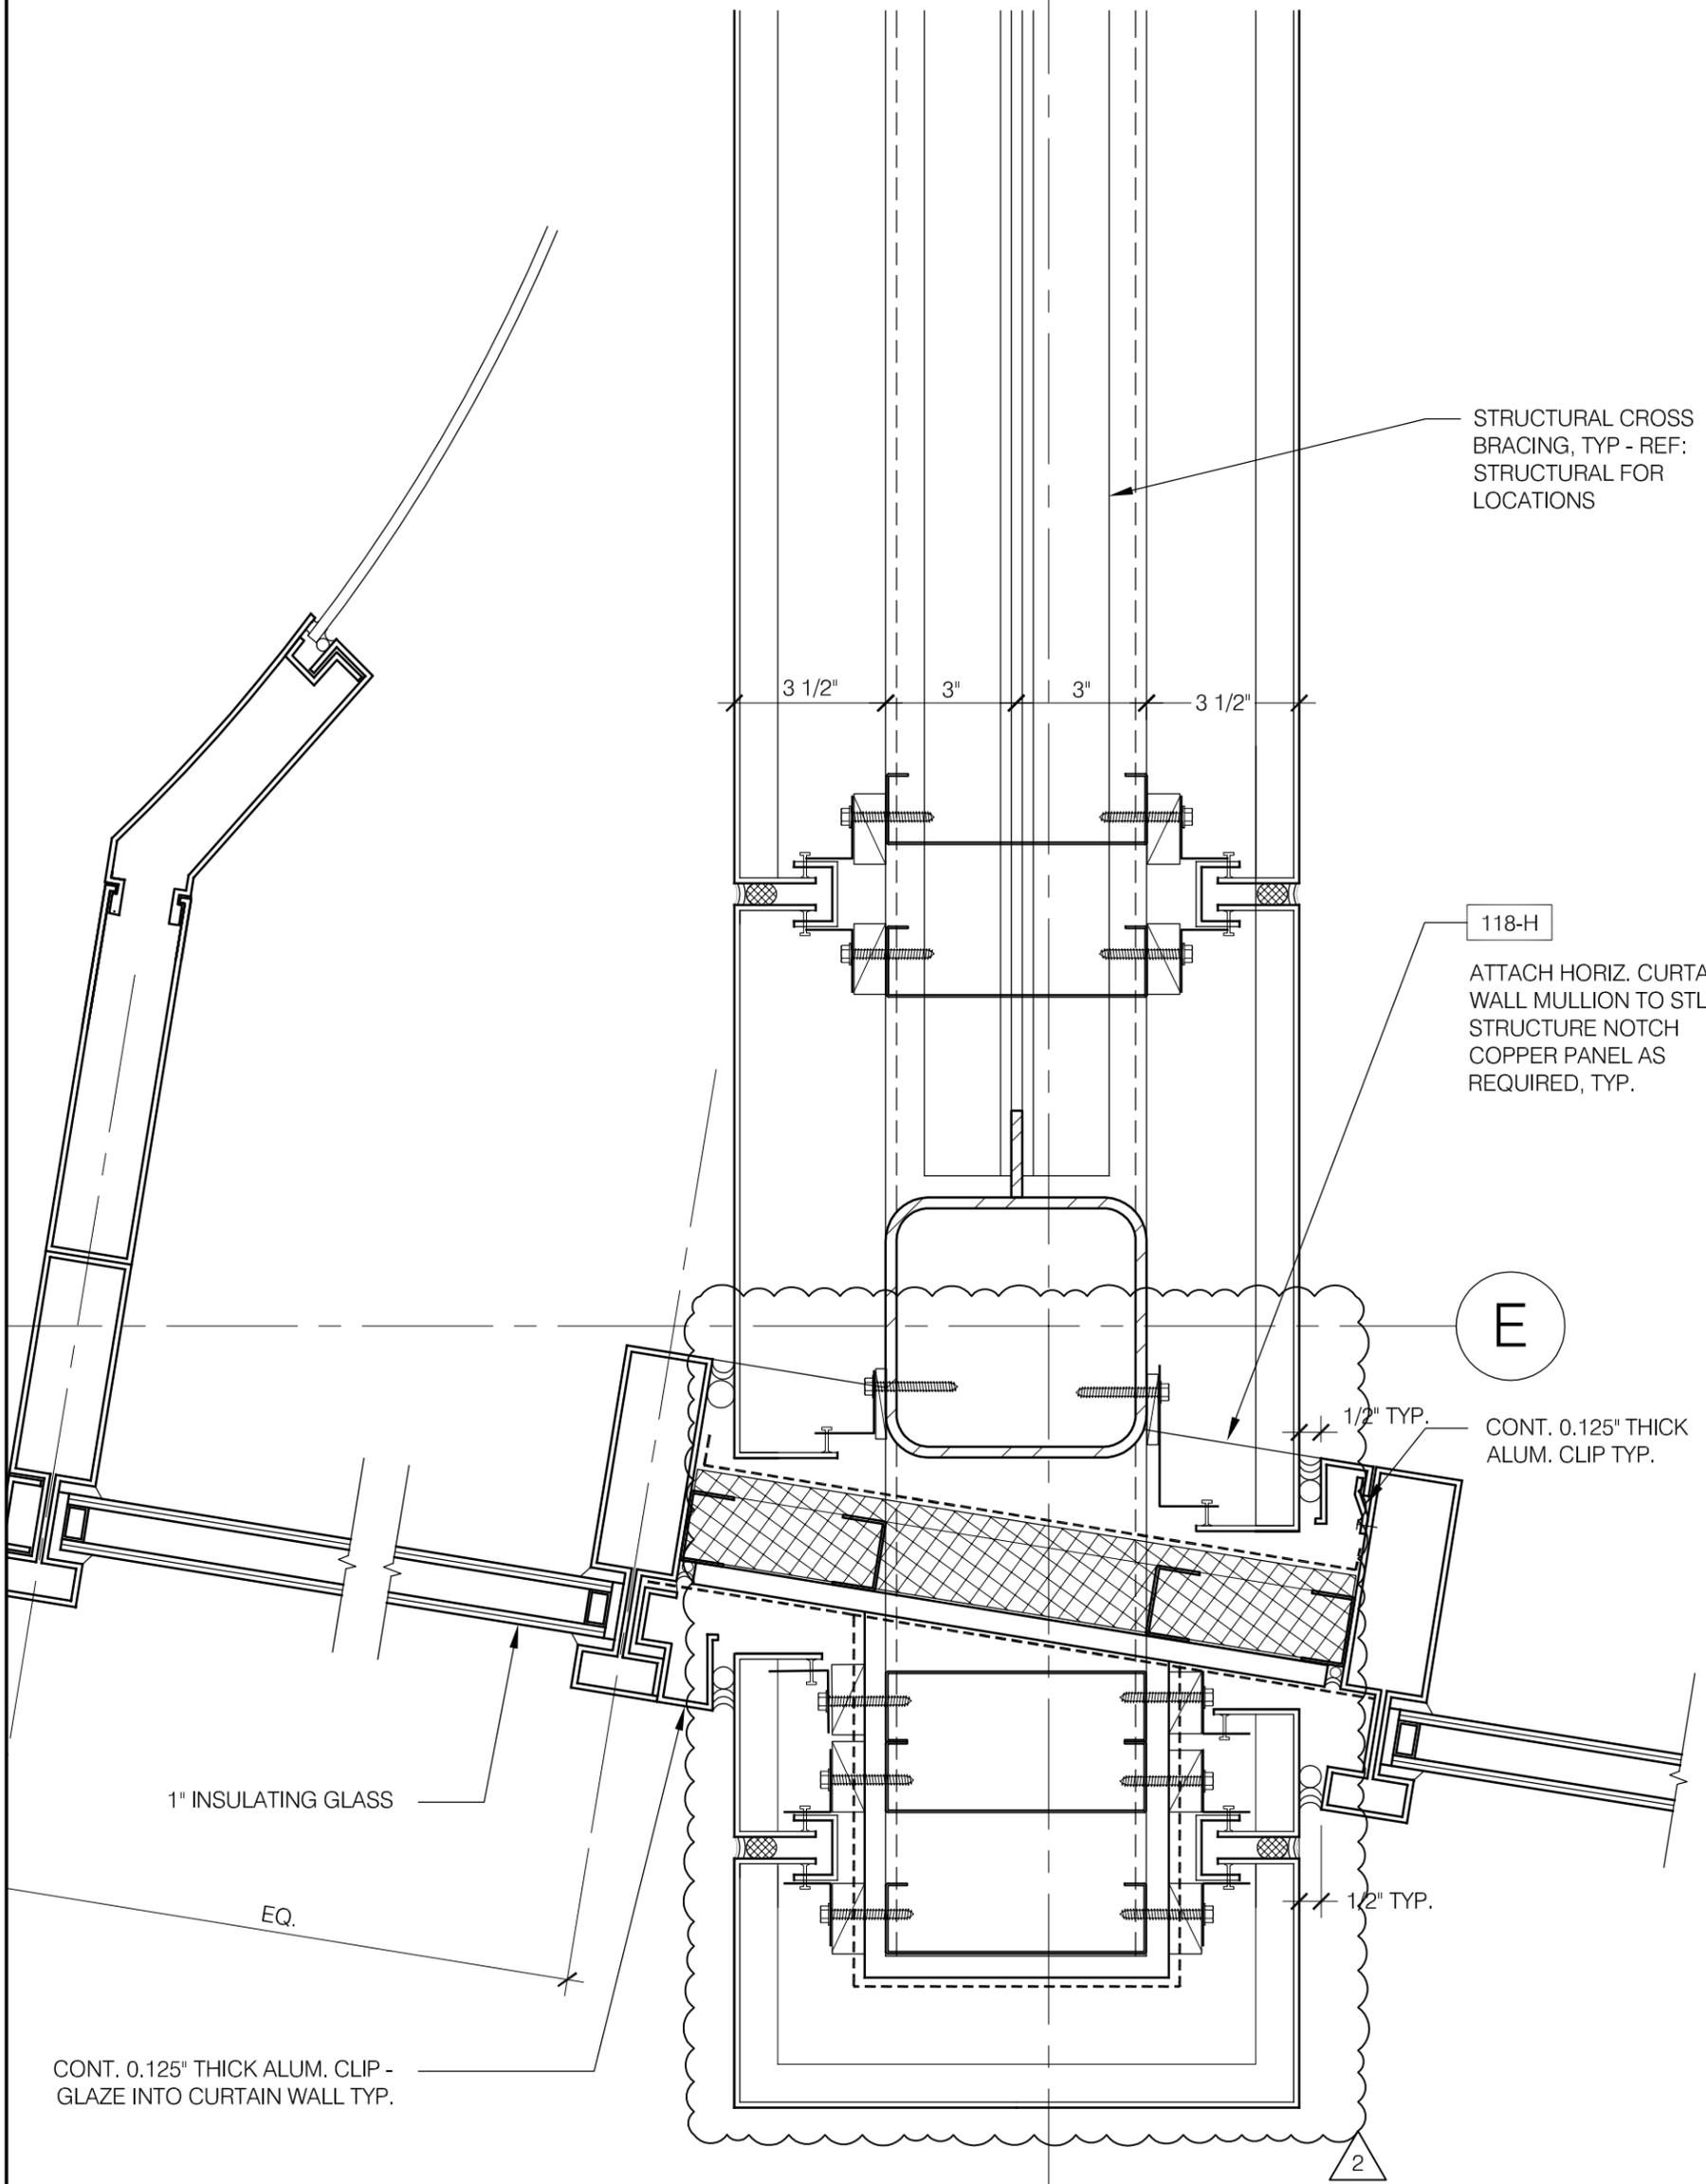

STRUCTURAL CROSS BRACING, TYP - REF: STRUCTURAL FOR LOCATIONS

118-H  
ATTACH HORIZ. CURTAIN WALL MULLION TO STL. STRUCTURE NOTCH COPPER PANEL AS REQUIRED, TYP.

E  
CONT. 0.125" THICK ALUM. CLIP TYP.

1" INSULATING GLASS

EQ.

CONT. 0.125" THICK ALUM. CLIP - GLAZE INTO CURTAIN WALL TYP.

2

FILE: U:\2443h-00 12th District Police Station\Drawings\Sheets\ASKs\ASK30.dwg  
Plot Date: 10/17/2008



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50 WEST WASHINGTON STREET  
CHICAGO, IL 60602  
DESCRIPTION:  
UPDATED PLAN DETAIL


**12th DISTRICT POLICE STATION**  
1412 SOUTH BLUE ISLAND AVENUE  
CHICAGO, IL 60608  
REVISION:  
ISSUED FOR ADDENDUM 2

SCALE:  
3"=1'-0"  
DATE:  
07/02/2010

DRAWN BY:  
LJH  
CHECKED BY:  
KMC

SHEET:  
**ASK.30**  
REFERENCE:  
**2/A6.2C**

FILE: U:\2443h-00 12th District Police Station\Drawings\Sheets\ASKs\ASK31.dwg  
 Plot Date: 10/17/2008

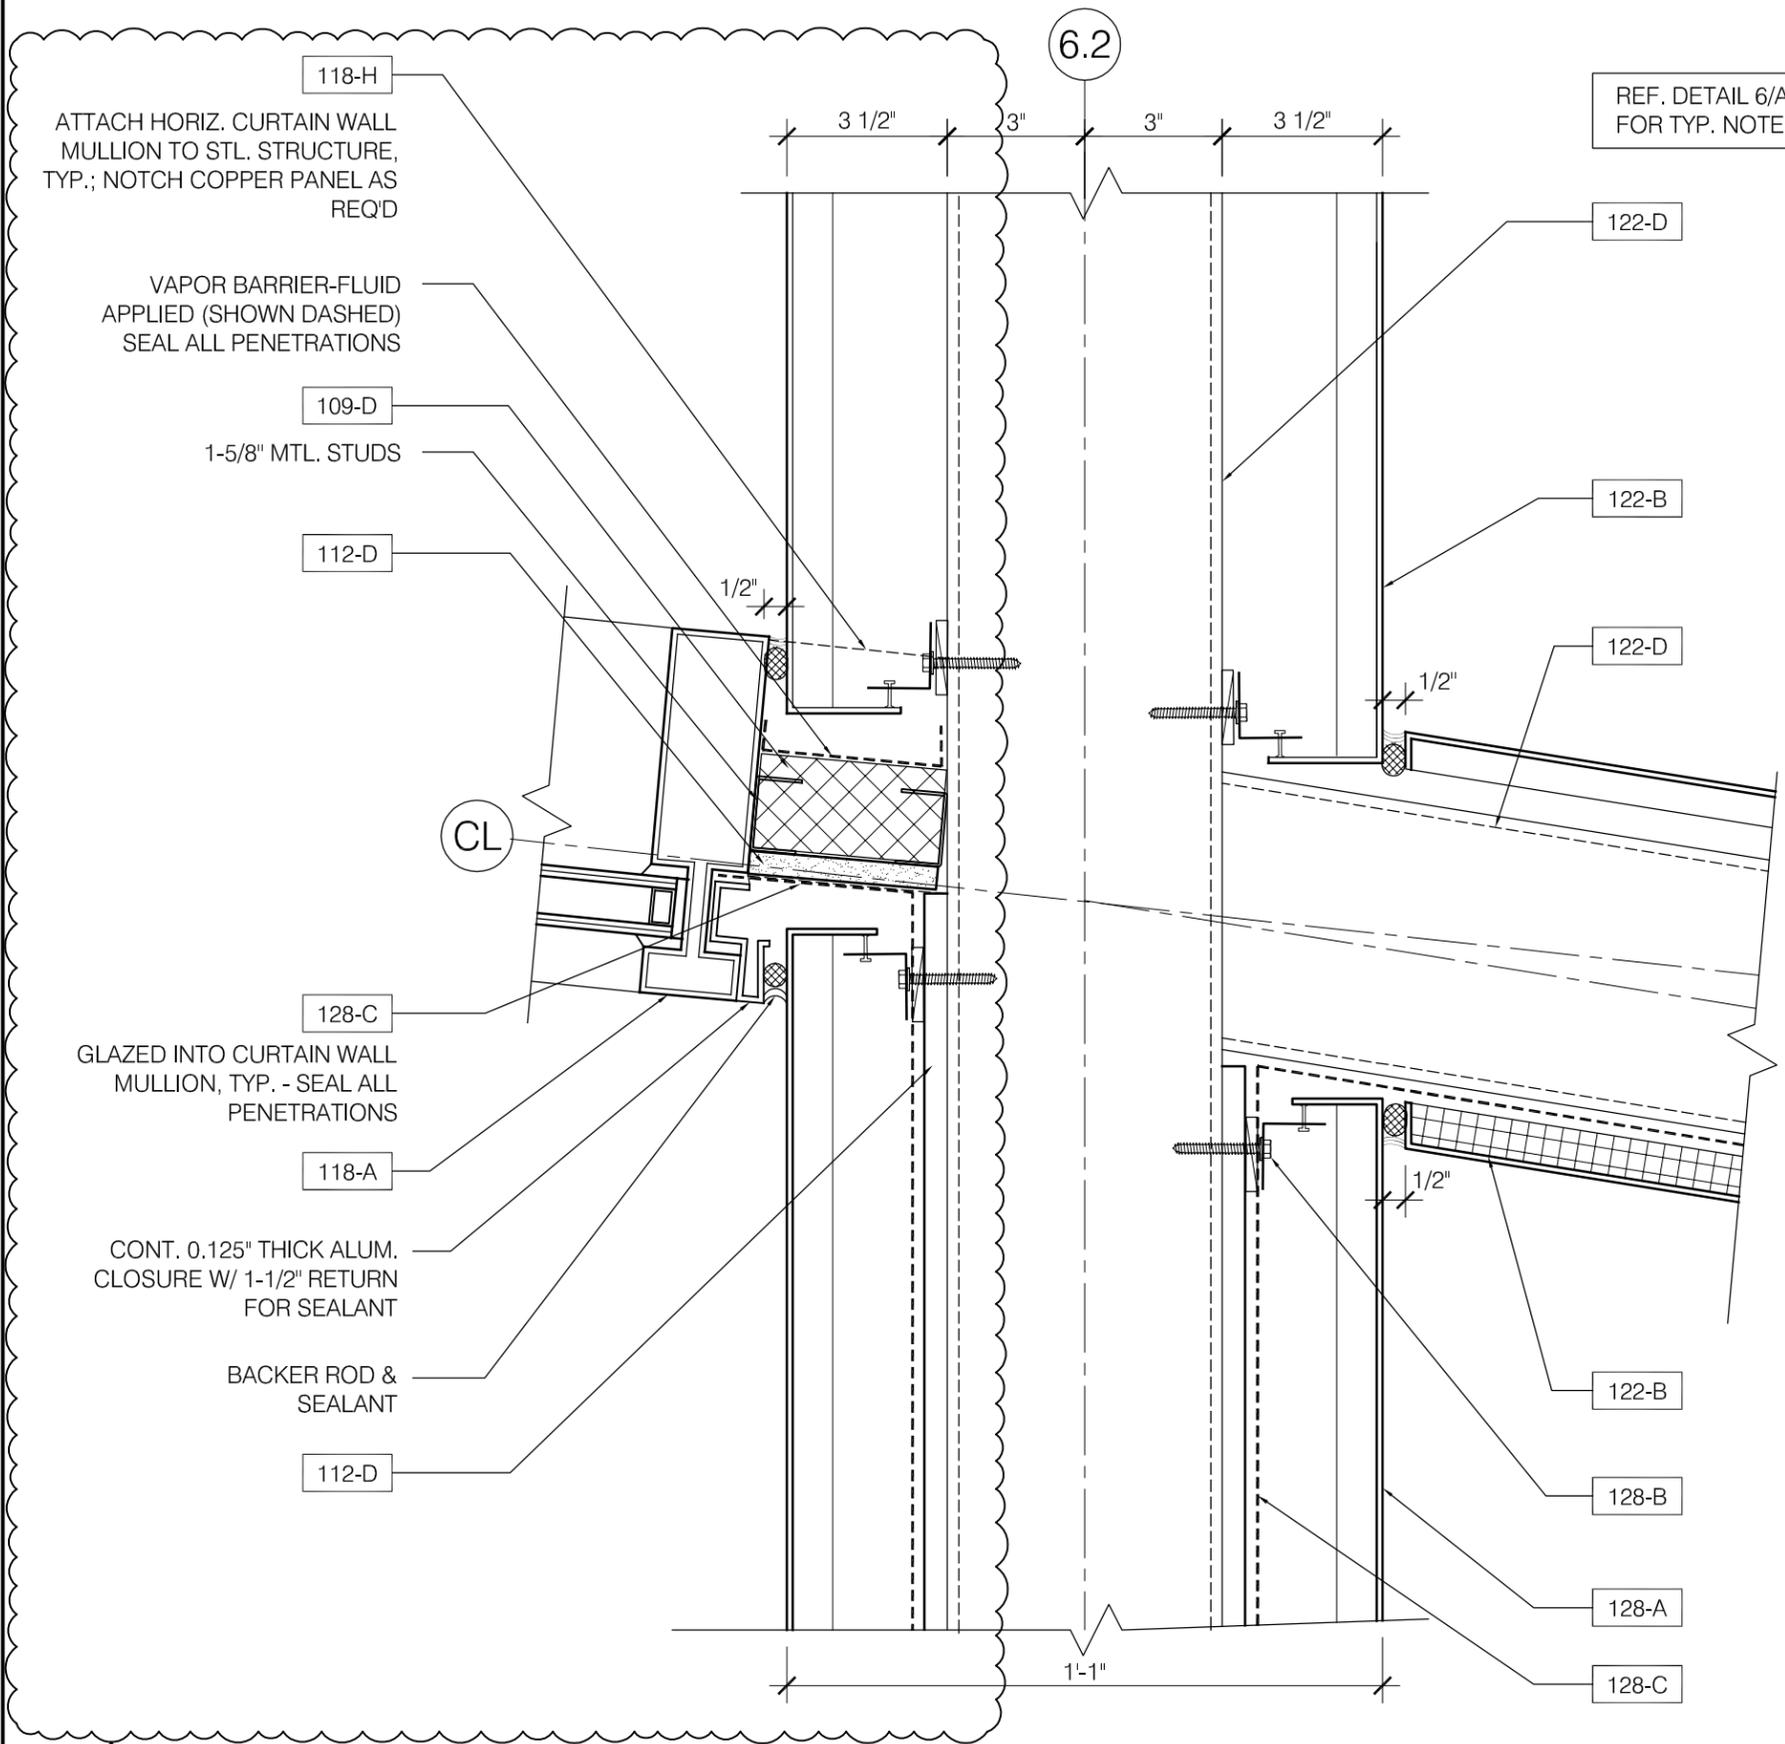


REF. DETAIL 6/A6.1  
 FOR TYP. NOTES

3 PLAN DETAIL @ TRELLIS  
 A6.2C 3"=1'-0"


<b>VOA ASSOCIATES, INC.</b> Architecture/Planning/Interior Design 224 South Michigan Avenue #1400 Chicago, Illinois 60604 PH: (312)554-1400 FAX: (312)554-1412	PUBLIC BUILDING COMMISSION OF CHICAGO 50 WEST WASHINGTON STREET CHICAGO, IL 60602	12th DISTRICT POLICE STATION 1412 SOUTH BLUE ISLAND AVENUE CHICAGO, IL 60608	SCALE: AS NOTED	DRAWN BY: LJH	SHEET: <b>ASK.31</b>
	DESCRIPTION: UPDATED PLAN DETAIL	REVISION: ISSUED FOR ADDENDUM 2	DATE: 07/02/2010	CHECKED BY: KMC	REFERENCE: <b>3/A6.2C</b>

FILE: U:\2443h-00 12th District Police Station\Drawings\Sheets\ASKs\ASK32.dwg  
 Plot Date: 10/17/2008

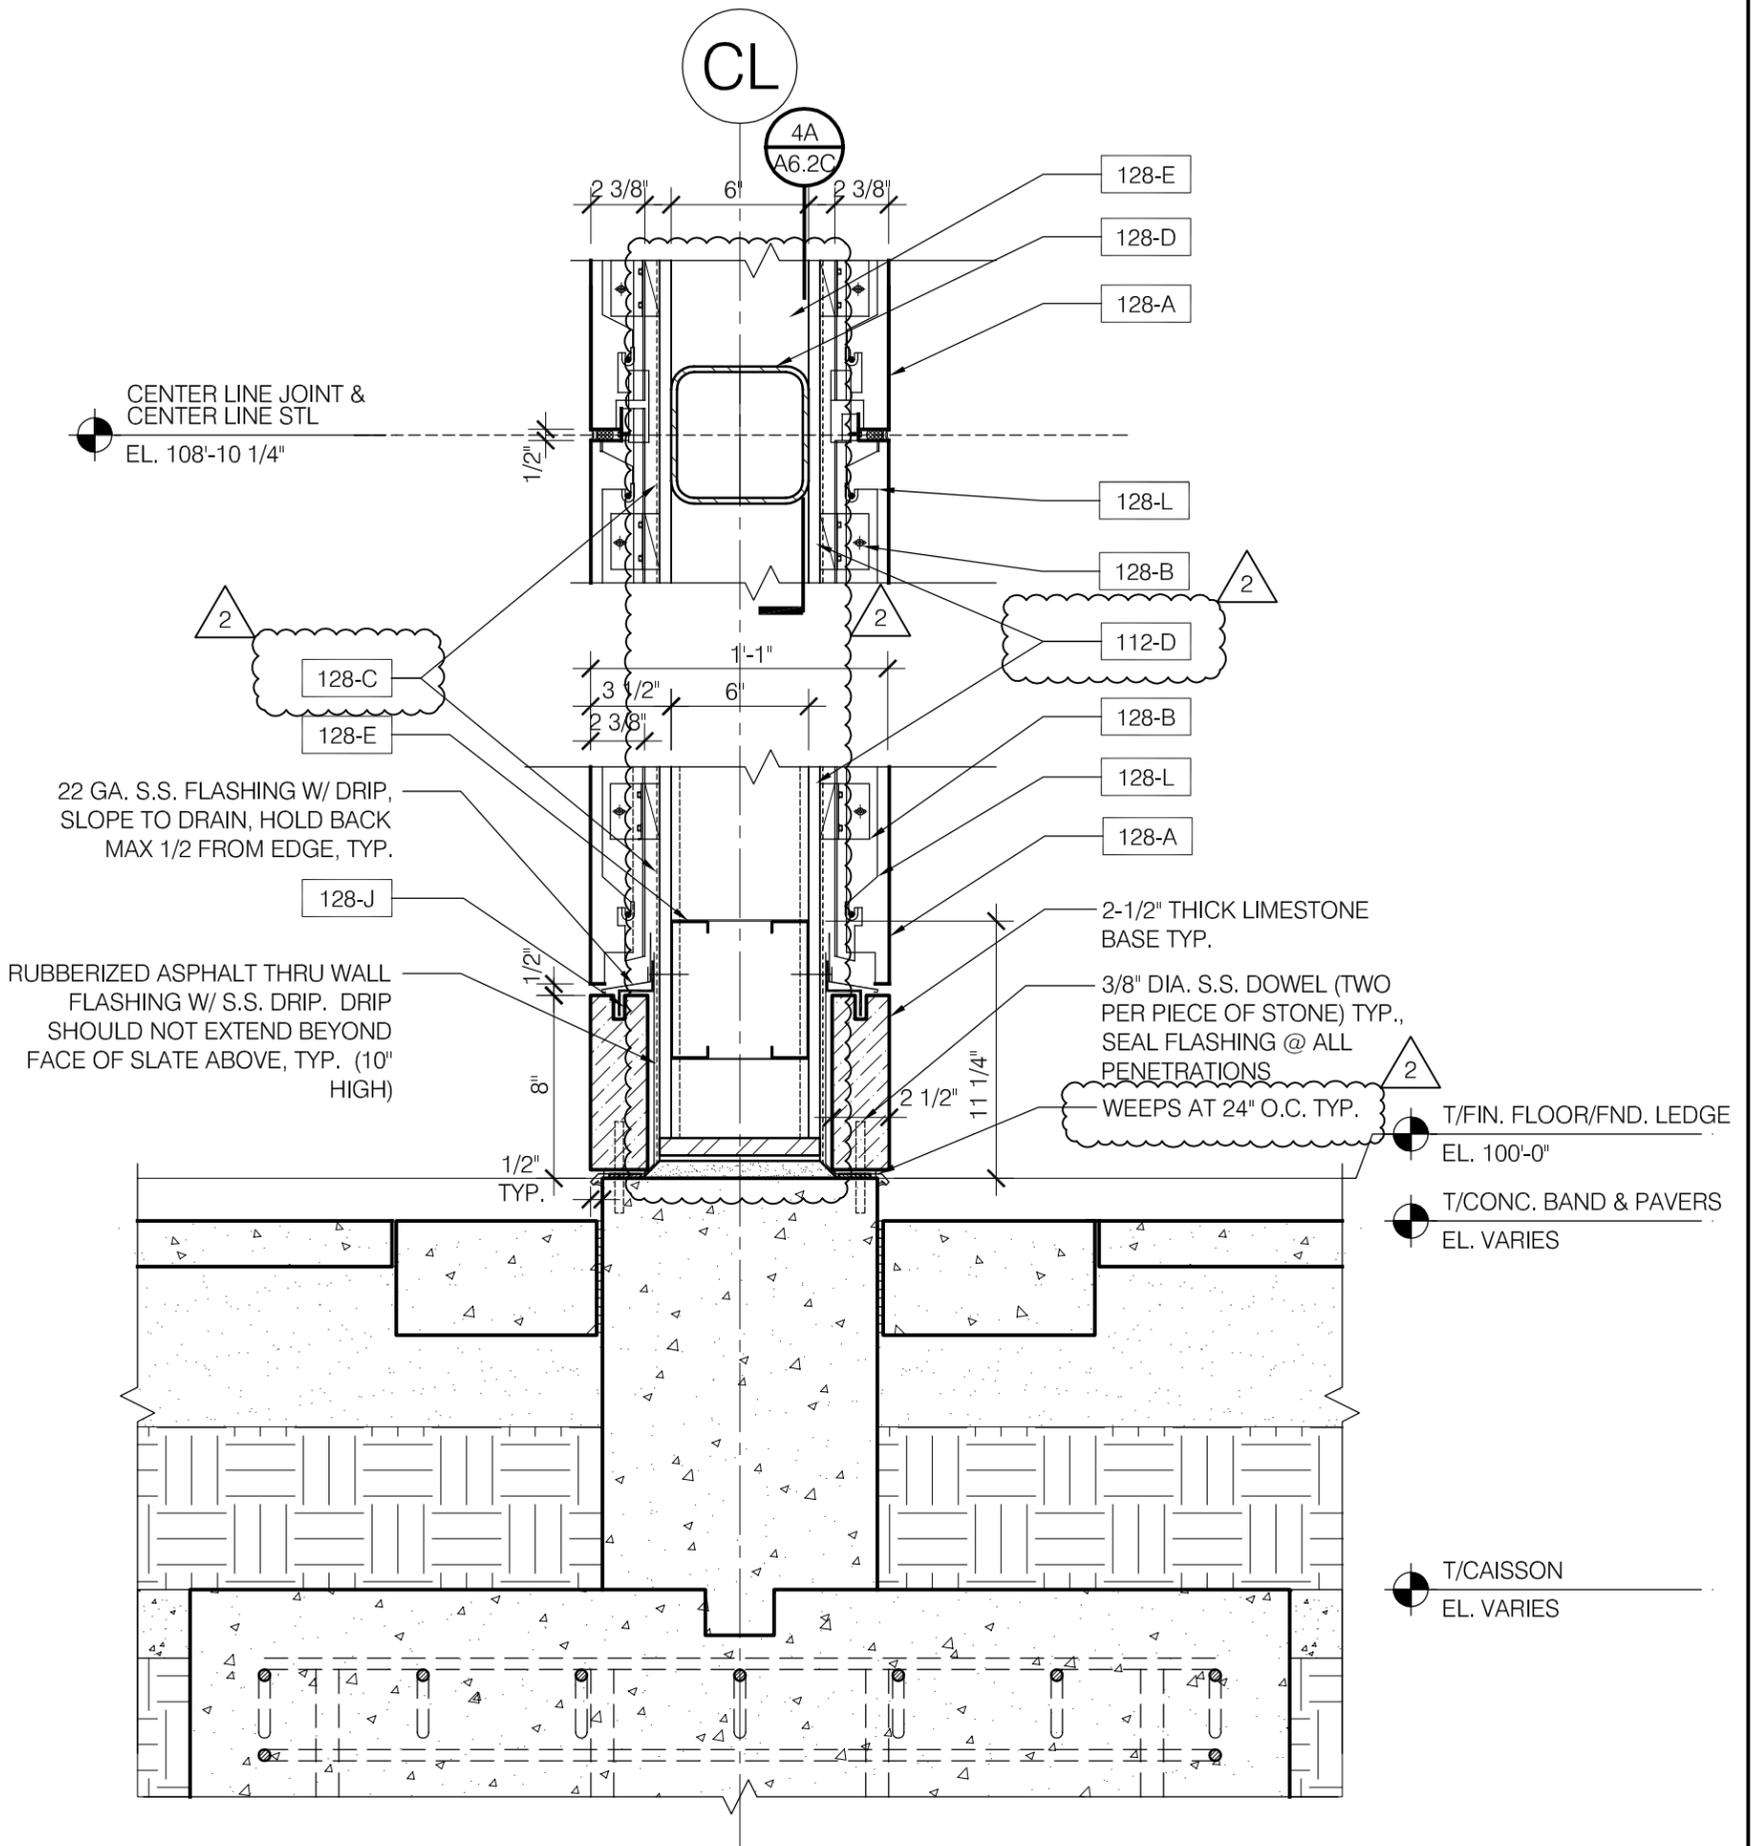

4 SECTION DETAIL @ COLUMN  
 A6.2C 1 1/2" = 1'-0"

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	DESCRIPTION: UPDATED PLAN DETAIL	REVISION: ISSUED FOR ADDENDUM 2	DATE: 07/02/2010	CHECKED BY: KMC	REFERENCE: 4/A6.2C

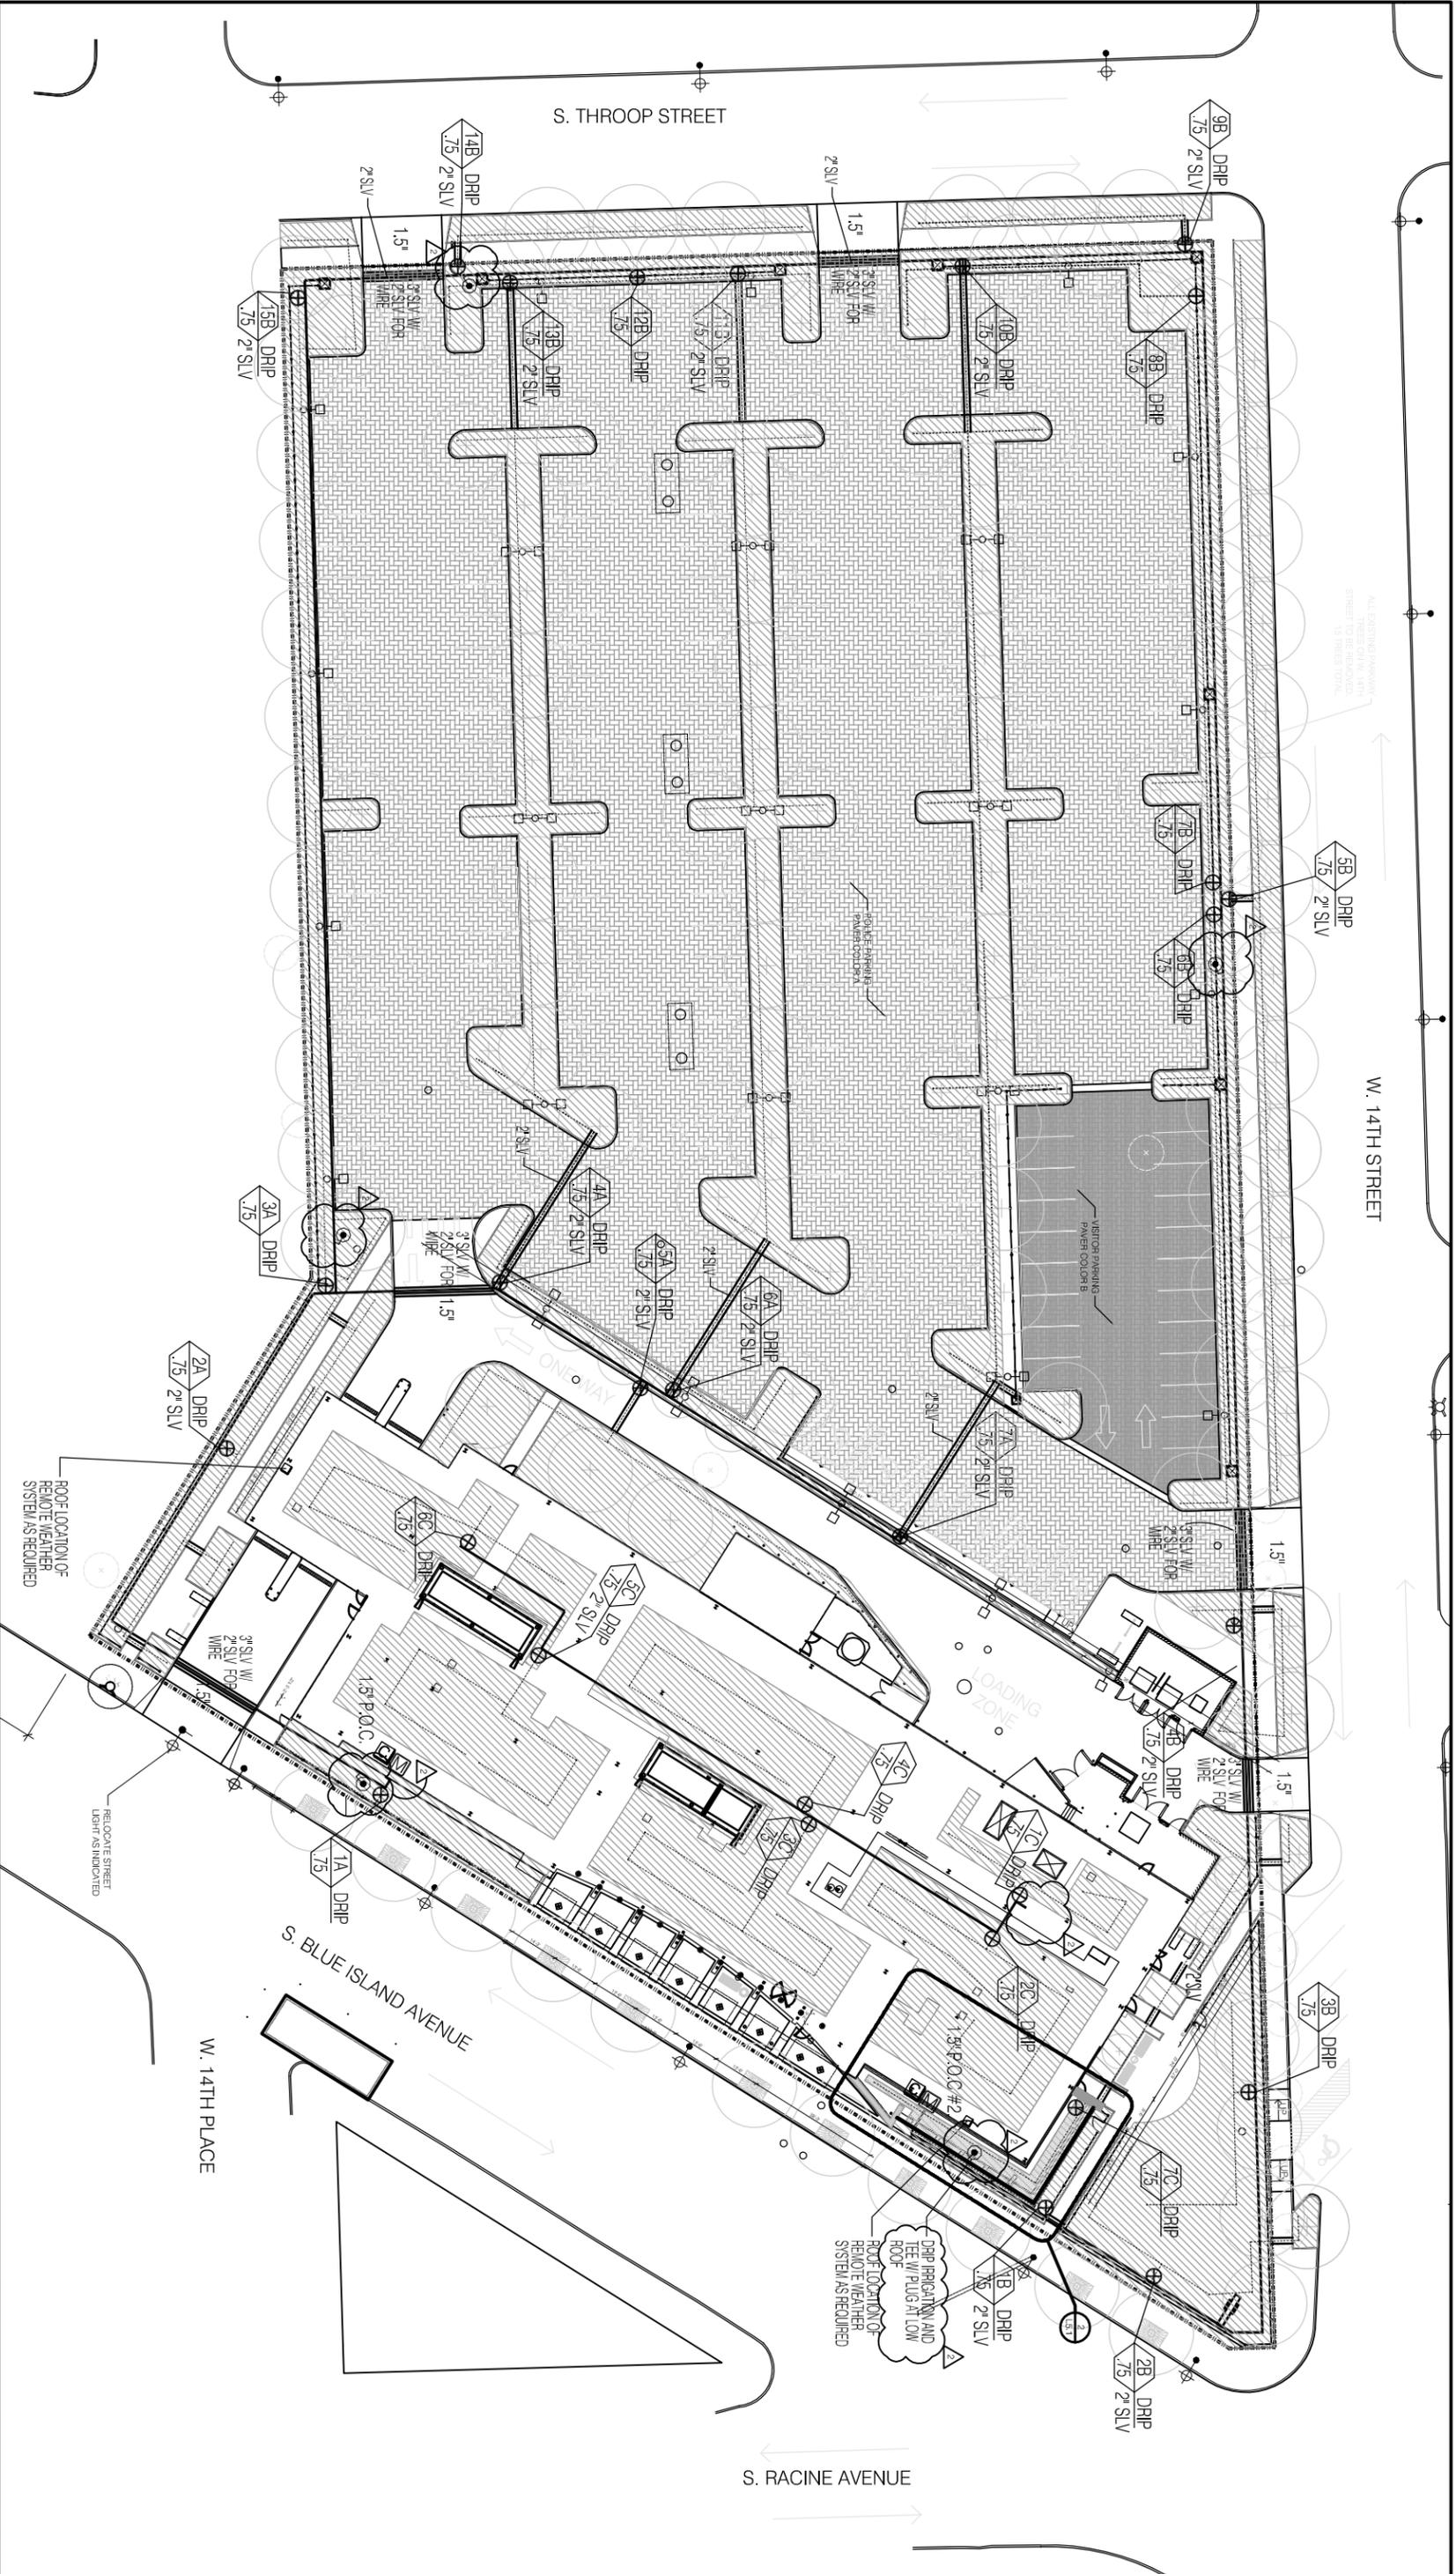

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**PUBLIC BUILDING COMMISSION OF CHICAGO**  
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 CHICAGO, IL 60602  
**12th DISTRICT POLICE STATION**  
 1412 SOUTH BLUE ISLAND AVENUE  
 CHICAGO, IL 60608

DESCRIPTION:	UPDATED IRRIGATION PLAN	DRAWN BY:	LJH	SCALE:	NTS	SHEET:	ASK.33
REVISION:	ADDENDUM 2	CHECKED BY:	KMC	DATE:	07/02/2010	REFERENCE:	1/L5.1


# LEGEND

2

DESCRIPTION	MANUFACTURER (BASIS OF DESIGN)
TEE W/ PLUG, QTY 5; SEE NOTE 8	Rain Bird 5RC
Xerigation Control Valve	Rain Bird XCZ-LF-075-BFF
Dripline	Rain Bird LD-09-18
A	
1" Meter	
Controller	Rain Bird ESP-LXMI - 7 STATIONS
B & C	
1" Meter	
Controller	Rain Bird ESP-LXMI - 22 STATIONS
1" 200 PSI SDR 21 PVC LATERAL & MAINLINE PIPE	
1.25" 160 PSI SDR 26 PVC LATERAL & MAINLINE PIPE	
1.5" 160 PSI SDR 26 PVC LATERAL & MAINLINE PIPE	
2" 160 PSI SDR 26 PVC LATERAL & MAINLINE PIPE	

## NOTES:

- See specifications for information including but not limited to adhering to design intent, manufacturer substitutions, required shop drawings.
- The p.o.c. location on this drawing is an approximate location. Coordinate with MEP and other disciplines
- Controller location shall be determined by owner.
- All communication wire shall be placed in separate sleeving under all pavement, walks, etc. in excess of 10' width. All communication circuitry shall be run, whenever possible, with the main pipe line.
- Entire site to have low flow drip line irrigation including parkway and green roof.
- All roof rain water will be treated and stored in a cistern on site. This cistern will provide all water required for the irrigation system. Rain sensors and the use of drip-irrigation will be used to reduce water use.
- See L5.2 for additional irrigation notes.
- Provide tee with threaded cap for introducing compressed air for system winterization.

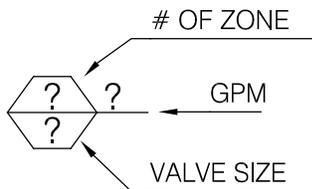

FILE: U:\2443n-00 12th District Police Station Drawings\Sheets\ASKs\ASK34.dwg

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PUBLIC BUILDING COMMISSION OF CHICAGO  
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 12th DISTRICT POLICE STATION  
 1412 SOUTH BLUE ISLAND AVENUE, CHICAGO, IL 60608

SCALE:  
 NTS

DRAWN BY:  
 LJH

SHEET:  
**ASK.34**


DESCRIPTION:  
 UPDATED NOTES AND LEGEND

REVISION:  
 ADDENDUM 2

DATE:  
 07/02/2010

CHECKED BY:  
 KMC

REFERENCE:  
**L5.1**

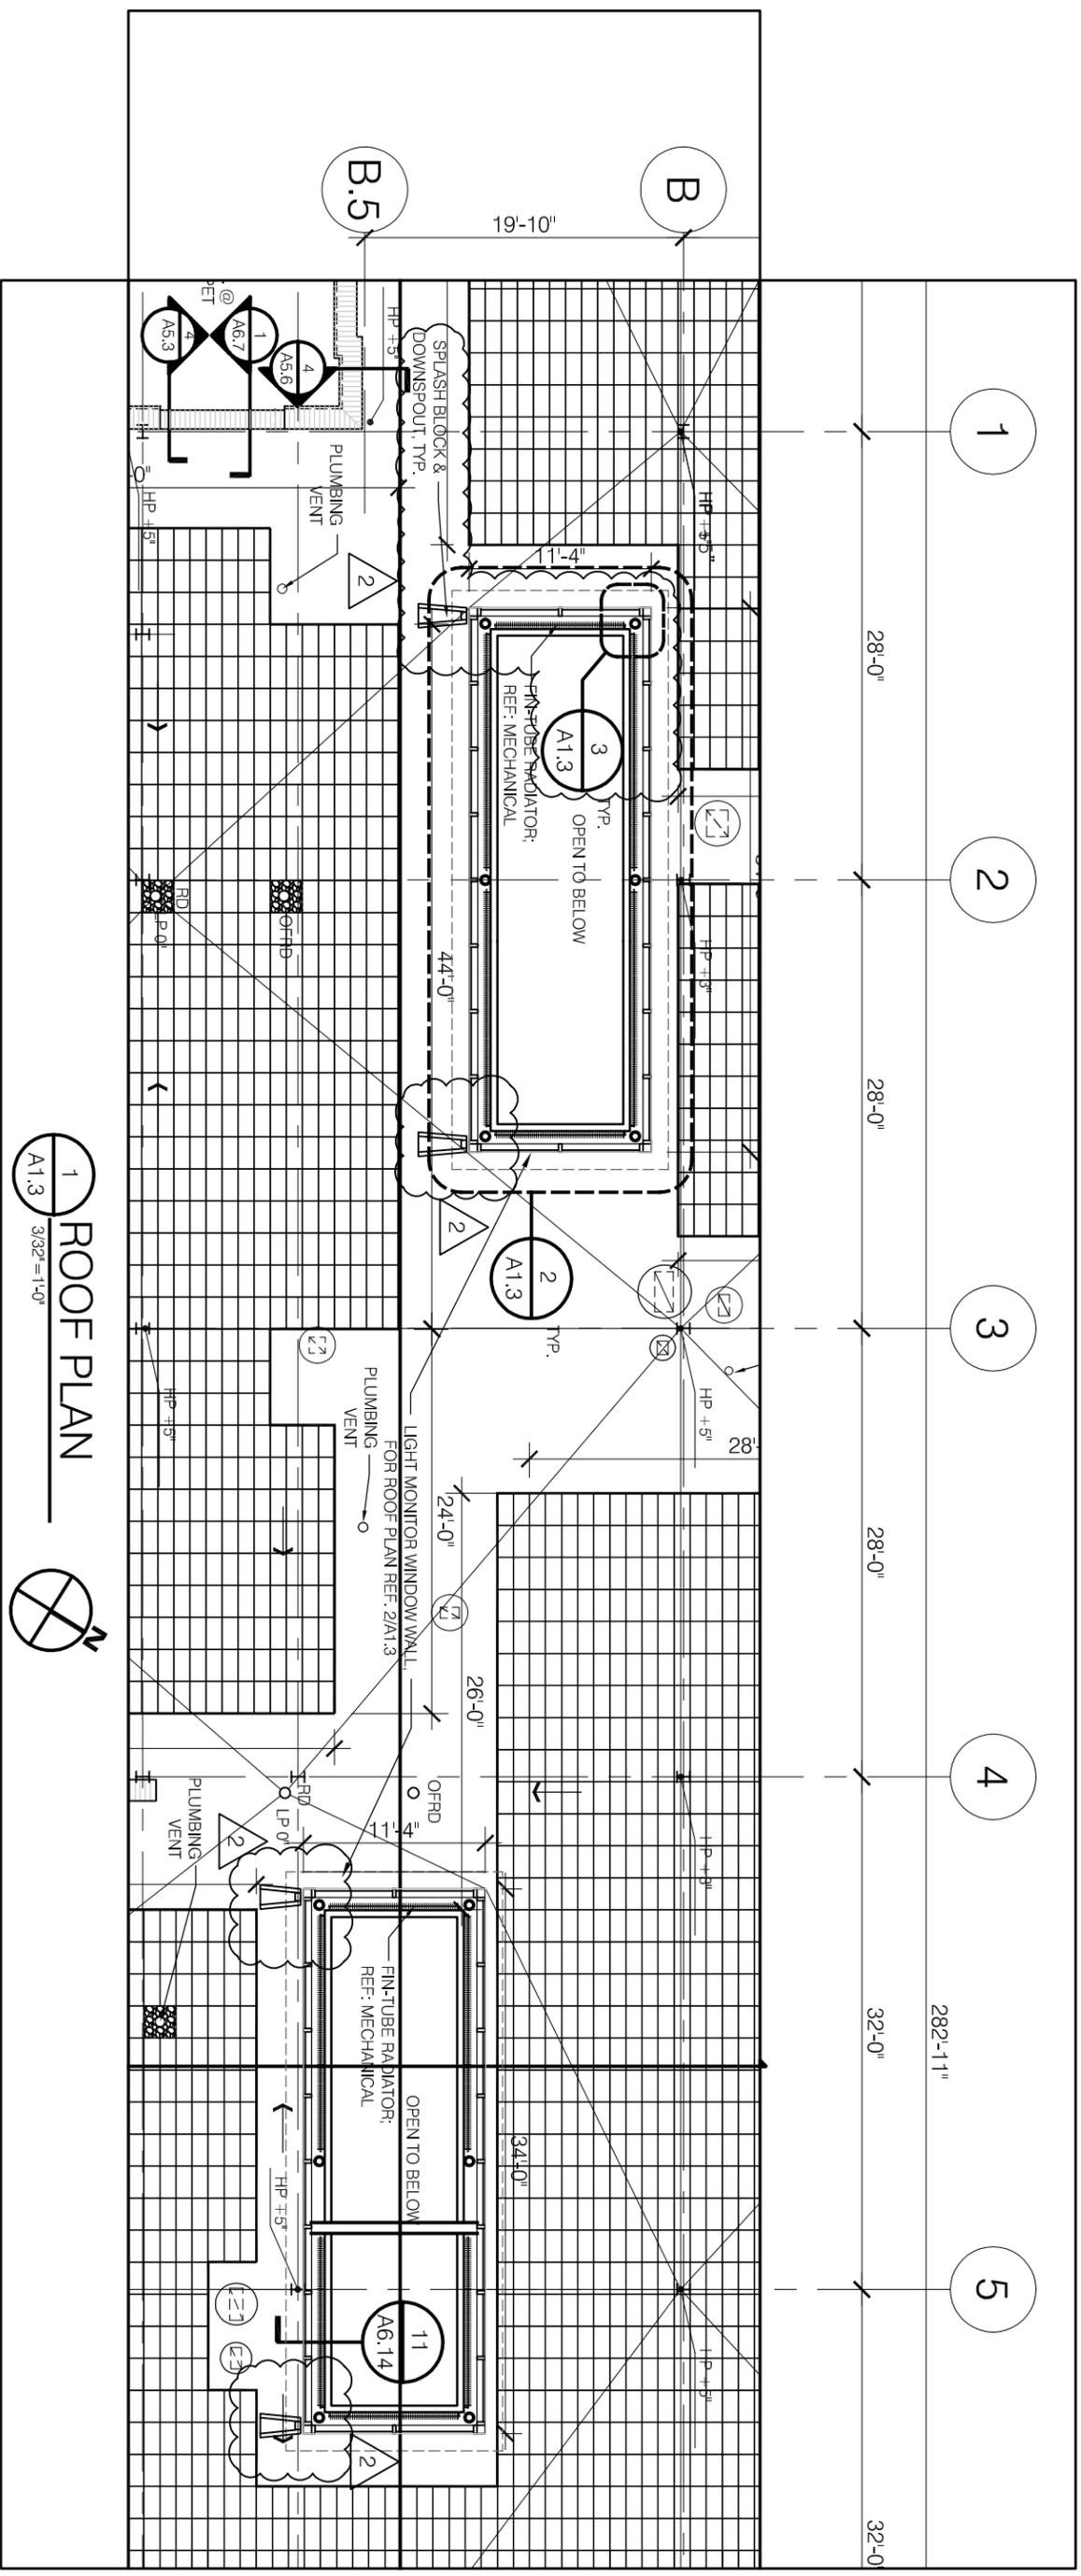

1 ROOF PLAN  
A1.3 3/32" = 1'-0"

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**12th DISTRICT POLICE STATION**  
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 CHICAGO, IL 60608

DESCRIPTION: UPDATED INTERIOR DETAILS	DRAWN BY: LJH	SCALE: AS NOTED	SHEET: <b>ASK.35</b>
REVISION: ADDENDUM 2	CHECKED BY: KMC	DATE: 07/02/2010	REFERENCE: <b>A1.3</b>



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**12th DISTRICT POLICE STATION**  
 1412 SOUTH BLUE ISLAND AVENUE  
 CHICAGO, IL 60608


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DRAWN BY:  
 LH

SCALE:  
 AS NOTED


SHEET:  
 REFERENCE:  
**ASK.36**  
**A1.3**

**3** DETAIL @ CORNER  
 A1.3 1 1/2" = 1'-0"

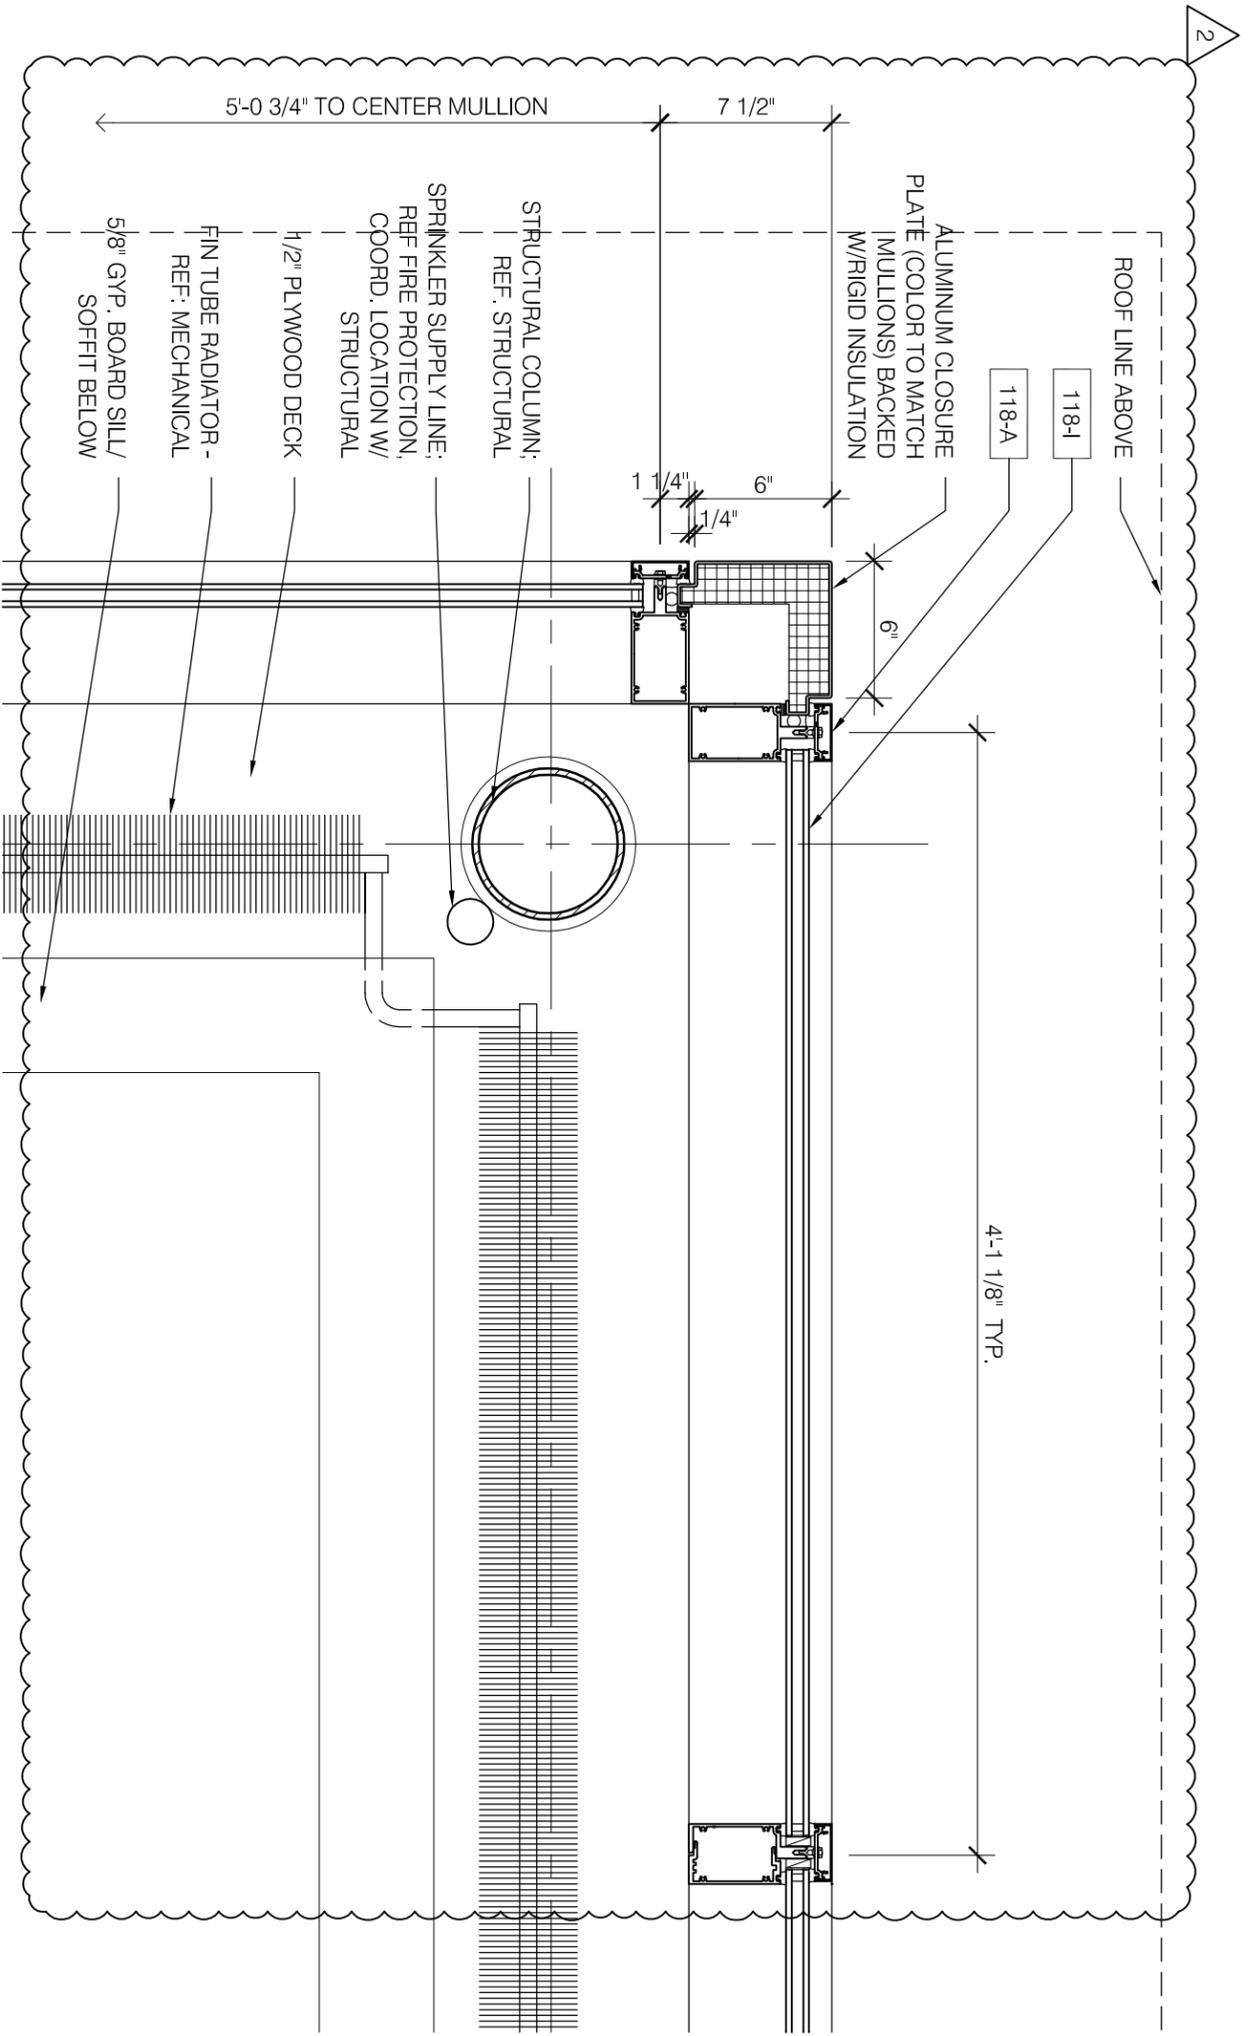

2



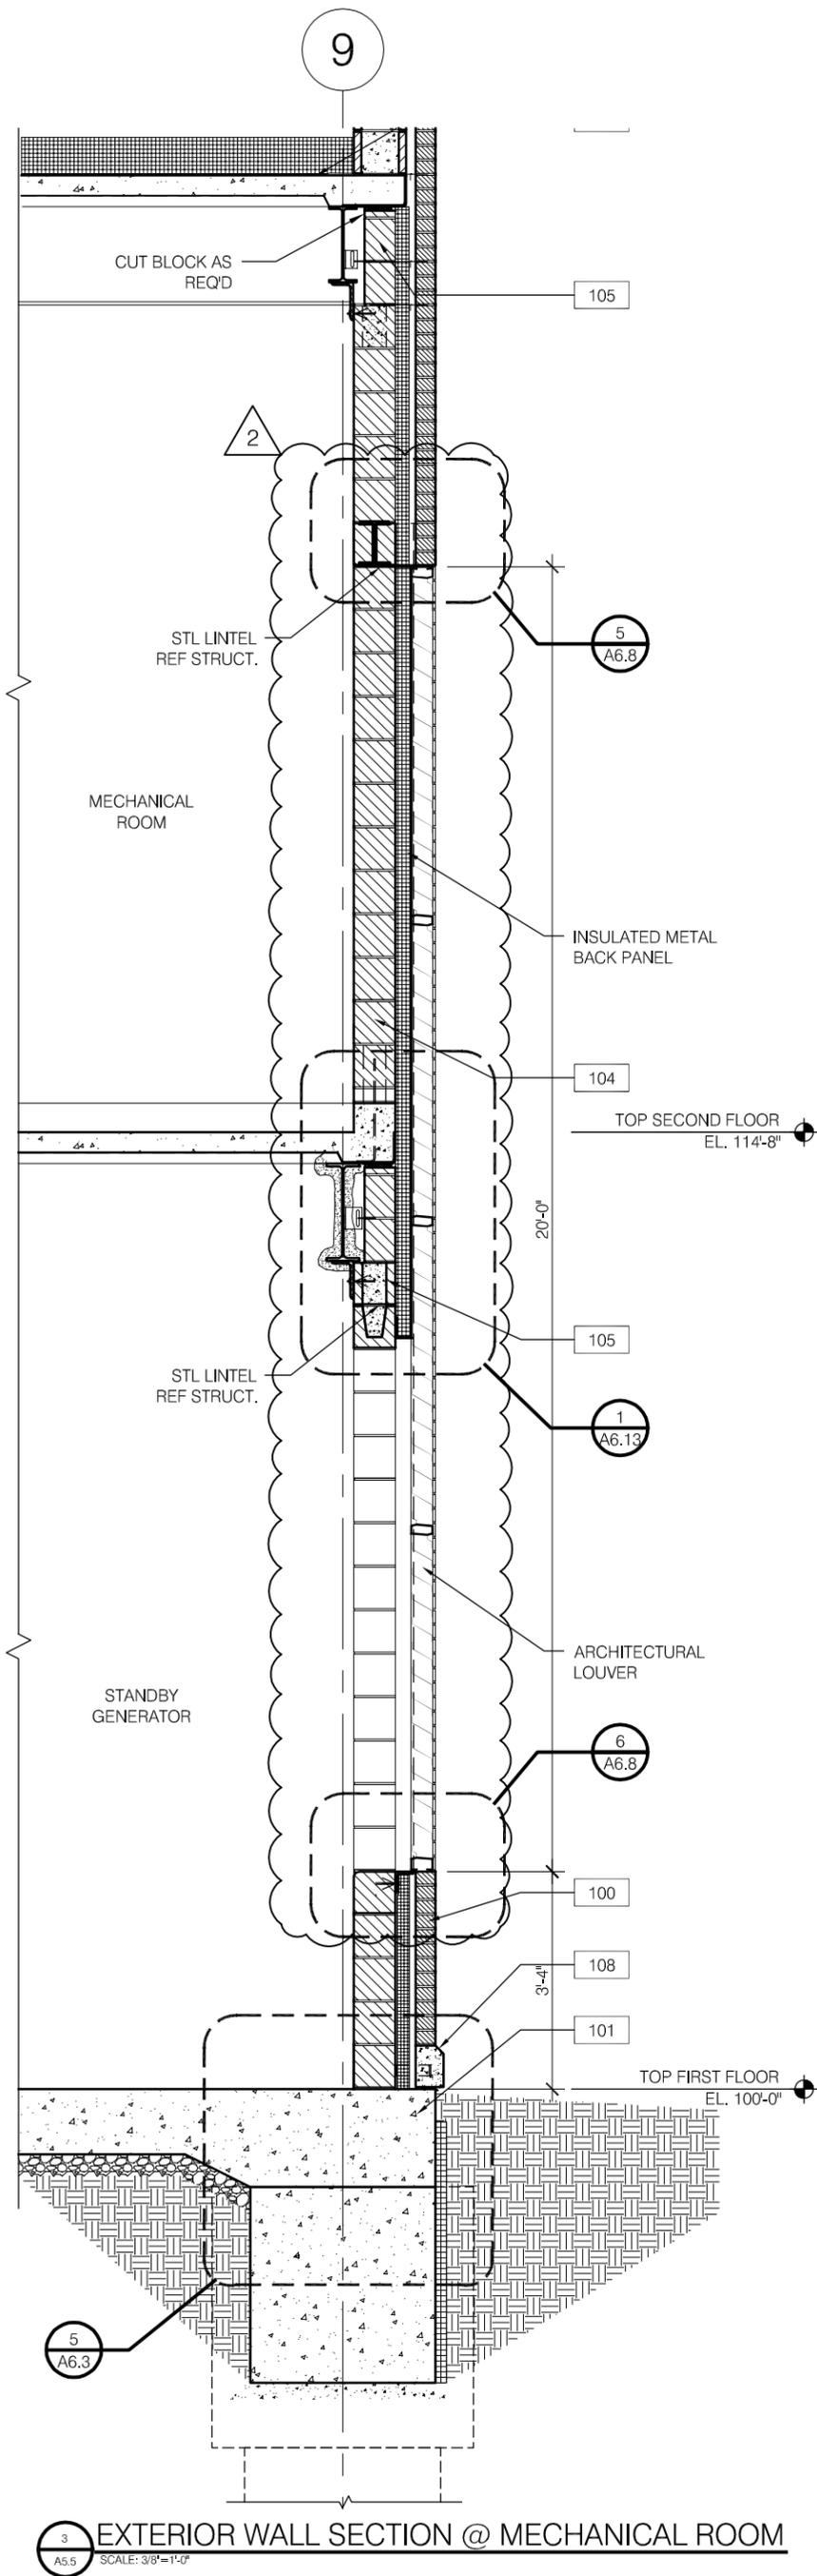

3 EXTERIOR WALL SECTION @ MECHANICAL ROOM  
A5.5 SCALE: 3/8"=1'-0"

FILE: U:\2443h-00 12th District Police Station\Drawings\Sheets\ASKs\ASK38.dwg  
Plot Date: 10/17/2008

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	DESCRIPTION: UPDATED WALL SECTION	REVISION: ISSUED FOR ADDENDUM 2	DATE: 07/02/2010	CHECKED BY: KMC	REFERENCE: <b>A.5.5</b>

PBC Control Rev: 1\_09/07/09 PD  
Project Rev C\_07/07/10


CHICAGO POLICE DEPARTMENT  
12<sup>TH</sup> DISTRICT POLICE STATION  
PBC-PROJECT# 09070

10425d -29

SIGNS

**Regulatory Information**

**Sign Type 25**

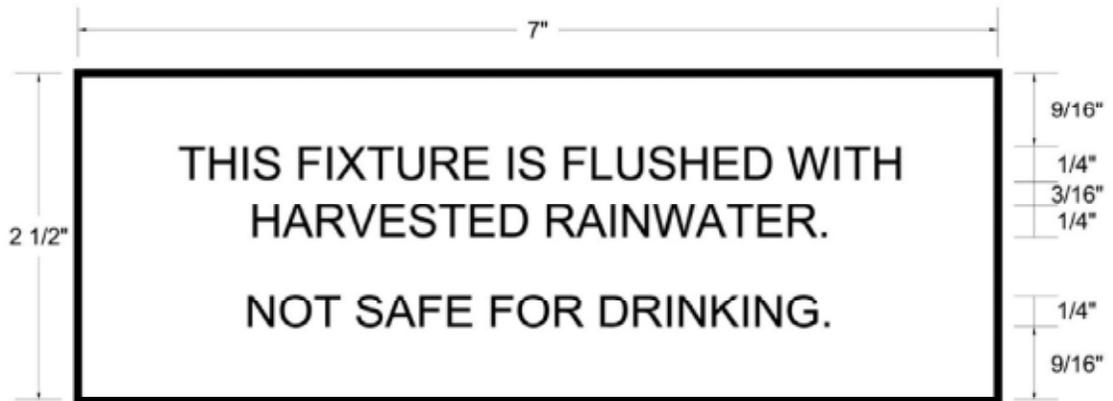

**FUNCTION**  
Rainwater Harvesting Regulatory Information at  
Each toilet and urinal

**SIZE**  
7"W X 2 1/2"H

**CONSTRUCTION**  
1/16" Photopolymer faceplate bonded to 1/8" acrylic sheet.  
Mount faceplate to wall with foam tape.

**COLOR/FINISH**  
Background: Black.  
Message/Letters: Yellow PMS 012.

**GRAPHICS:**  
1/4" Helvetica Caps, Center Justified, raised 1/32".

FILE: U:\2443h-00 12th District Police Station\Drawings\Sheets\ASKs\ASK39.dwg

**VOA**

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PUBLIC BUILDING COMMISSION OF CHICAGO  
50 WEST WASHINGTON STREET, CHICAGO, IL 60602  
12th DISTRICT POLICE STATION  
1412 SOUTH BLUE ISLAND AVENUE, CHICAGO, IL 60608

DESCRIPTION:  
SIGN TYPE 25  
REGULATORY INFORMATION

REVISION:  
ADDENDUM 2


SCALE:  
NO SCALE  
DATE:  
07/07/2010

DRAWN BY:  
LJH  
CHECKED BY:  
KMC

SHEET:  
**ASK.39**  
REFERENCE:  
10245d

PRINTED: 07/06/2010


FILE: U:\2443h-00 12th District Police Station\Drawings\Sheets\ASKs\ASK40.dwg

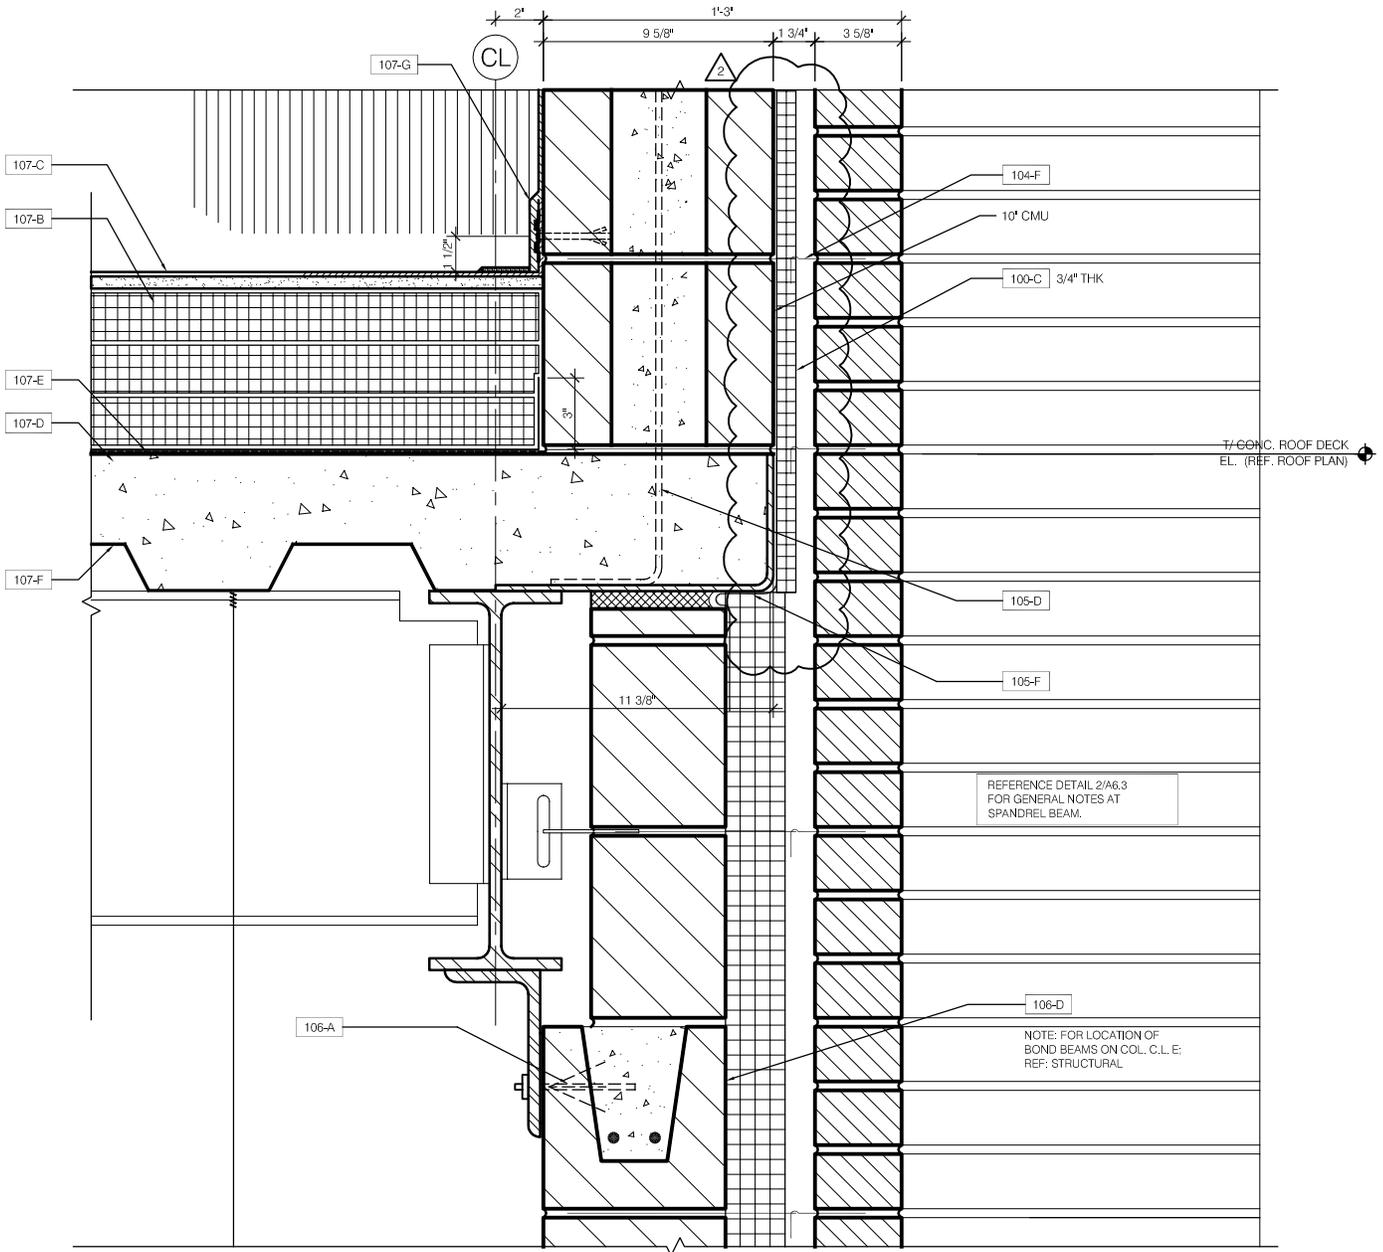

**1** DETAIL @ EXTERIOR WALL  
 A6.3 1 1/2" = 1'-0"


<b>VOA ASSOCIATES, INC.</b> Architecture/Planning/Interior Design 224 South Michigan Avenue #1400 Chicago, Illinois 60604 PH: (312)554-1400 FAX:(312)554-1412	PUBLIC BUILDING COMMISSION OF CHICAGO 50 WEST WASHINGTON STREET, CHICAGO, IL 60602 12th DISTRICT POLICE STATION 1412 SOUTH BLUE ISLAND AVENUE, CHICAGO, IL 60608	SCALE: AS NOTED	DRAWN BY: LJH	SHEET: <b>ASK.40</b>
	DESCRIPTION: UPDATED EXTERIOR WALL DETAIL	REVISION: ADDENDUM 2	DATE: 07/02/2010	CHECKED BY: KMC

PRINTED: 07/07/2010

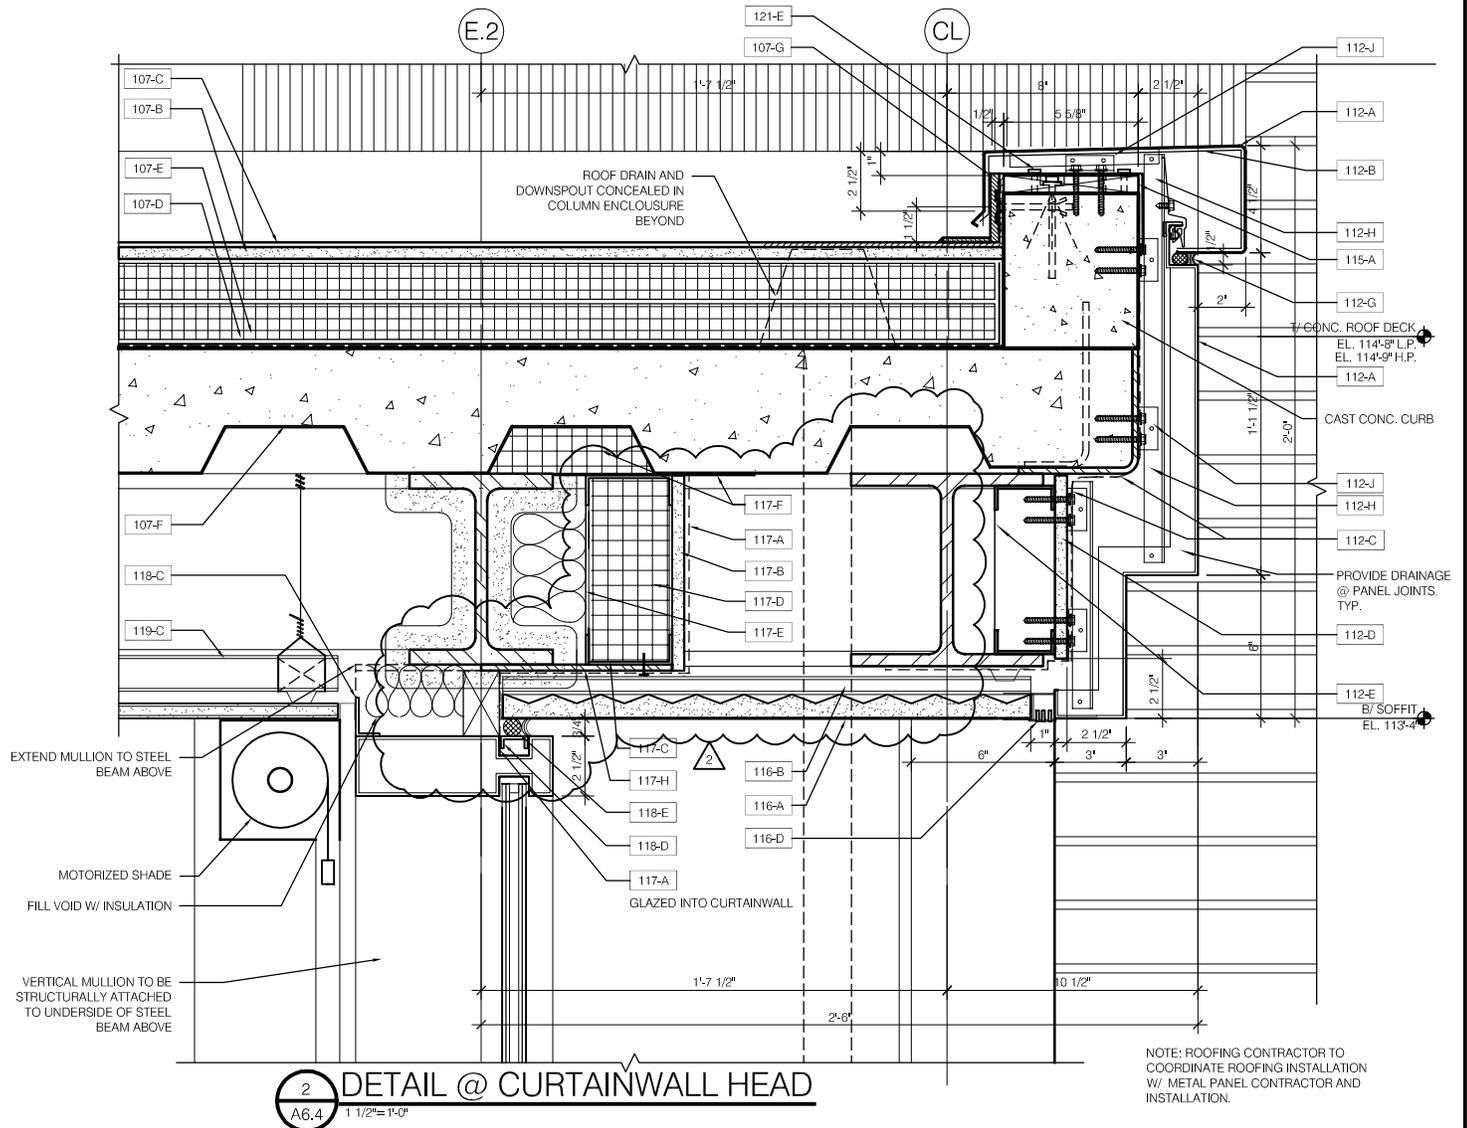

**2** DETAIL @ CURTAINWALL HEAD  
A6.4 1 1/2" = 1'-0"

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	DESCRIPTION: UPDATED DETAIL @ CURTAINWALL	REVISION: ADDENDUM 2	DATE: 07/02/2010	CHECKED BY: KMC

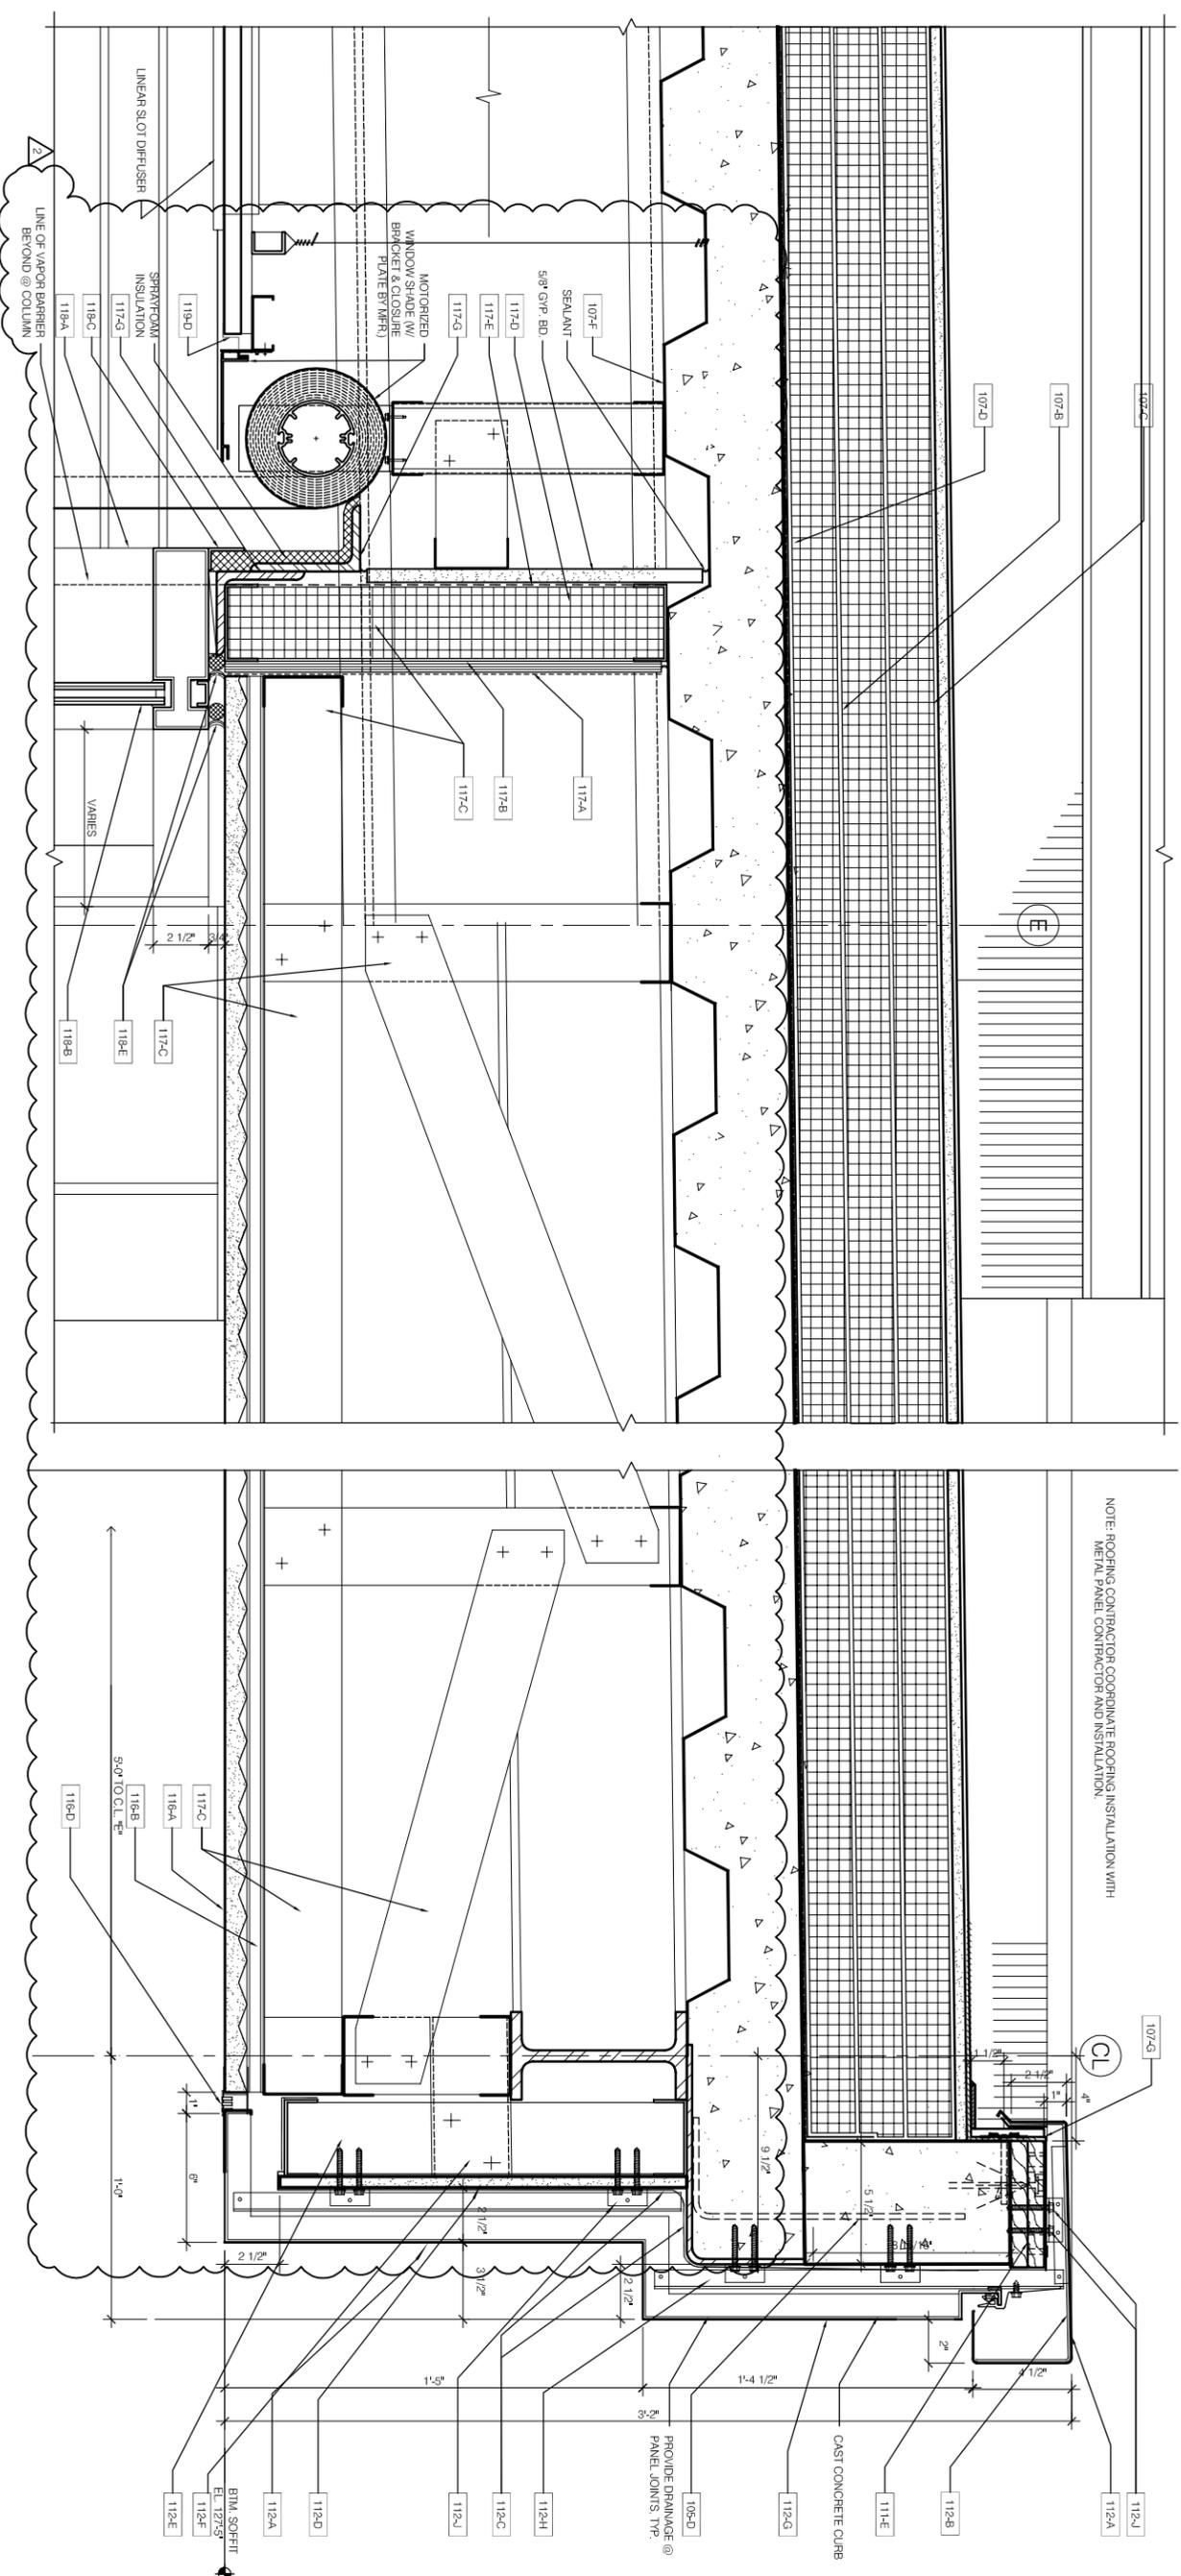

1 DETAIL @ LOBBY HIGH ROOF AND COPING  
A6.5 1 1/2\"/>

NOTE: COPING CONTRACTOR COORDINATE COPING INSTALLATION WITH METAL PANEL CONTRACTOR AND INSTALLATION.


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DESCRIPTION:	DRAWN BY:	SCALE:	SHEET:
UPDATED EXTERIOR DETAILS	LJH	AS NOTED	<b>ASK.42</b>
REVISION:	CHECKED BY:	DATE:	REFERENCE:
ADDENDUM 2	KMC	07/02/2010	<b>A6.5</b>

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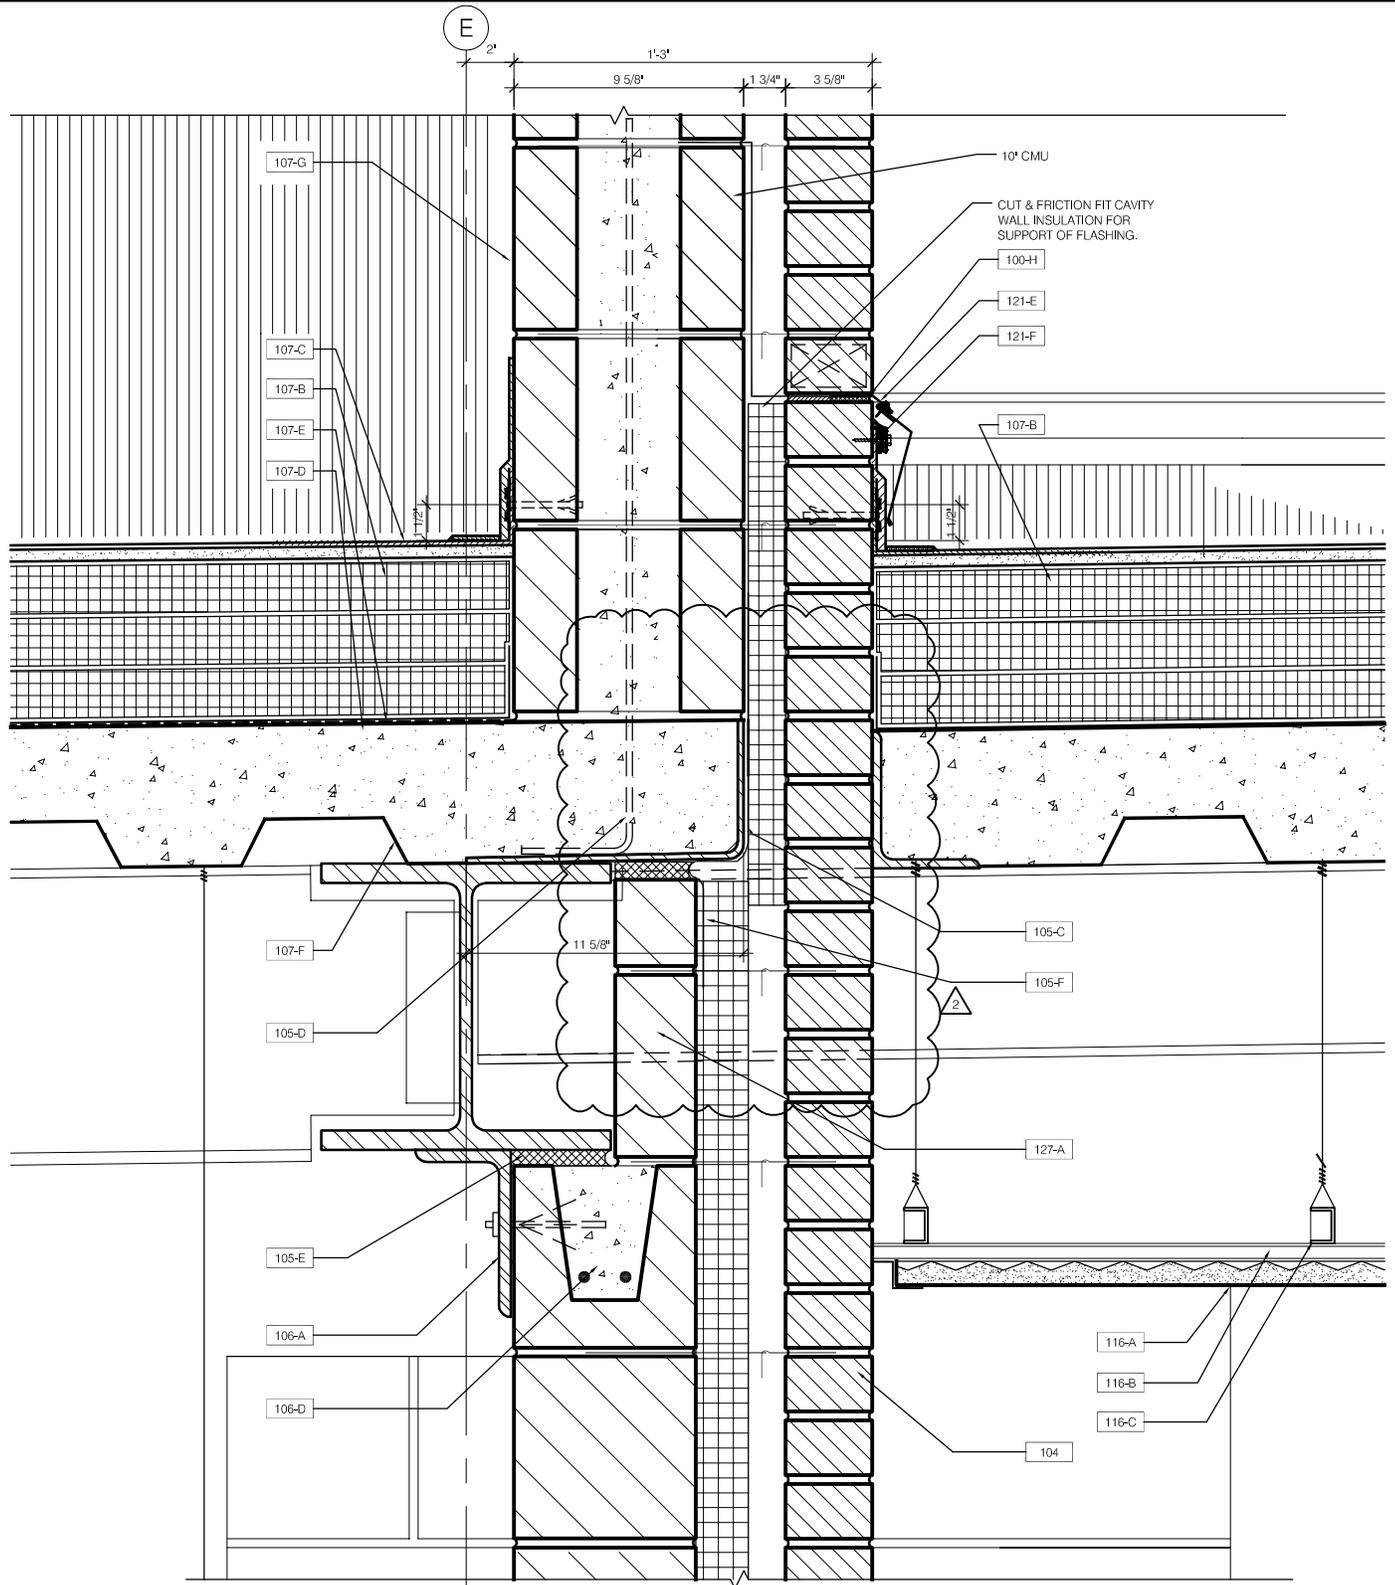


11 DETAIL @ WINDOW SILL  
A6.8 1 1/2" = 1'-0"

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	DESCRIPTION: UPDATED EXTERIOR WALL DETAIL	REVISION: ADDENDUM 2	DATE: 07/02/2010	CHECKED BY: KMC	REFERENCE: 11/A6.8

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FILE: U:\2443h-00 12th District Police Station\Drawings\Sheets\ASKs\ASK44.dwg

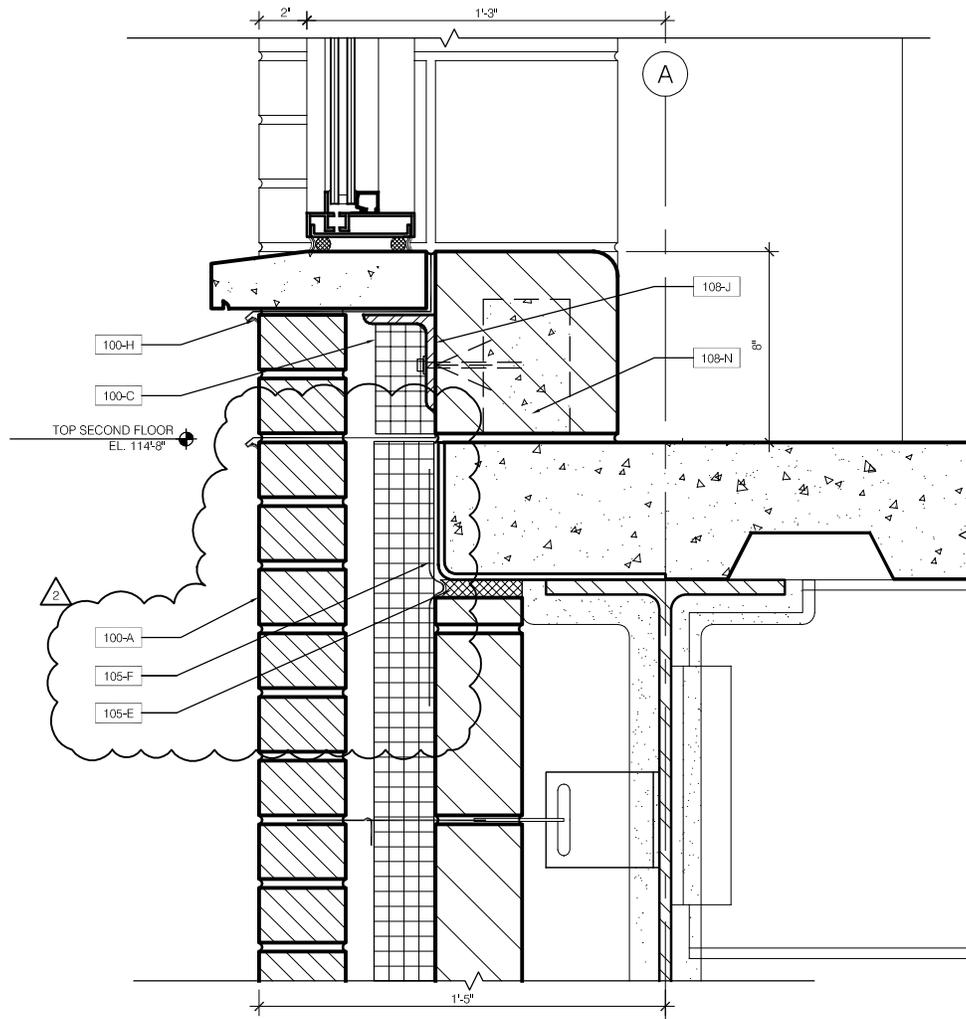


**2** DETAIL @ LOBBY OVERHANG  
A6.9 1 1/2"=1'-0"

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	DESCRIPTION: UPDATED EXTERIOR WALL DETAIL	REVISION: ADDENDUM 2	DATE: 07/02/2010	CHECKED BY: KMC	REFERENCE: 2/A6.9

PRINTED: 07/06/2010

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7  
A12.3
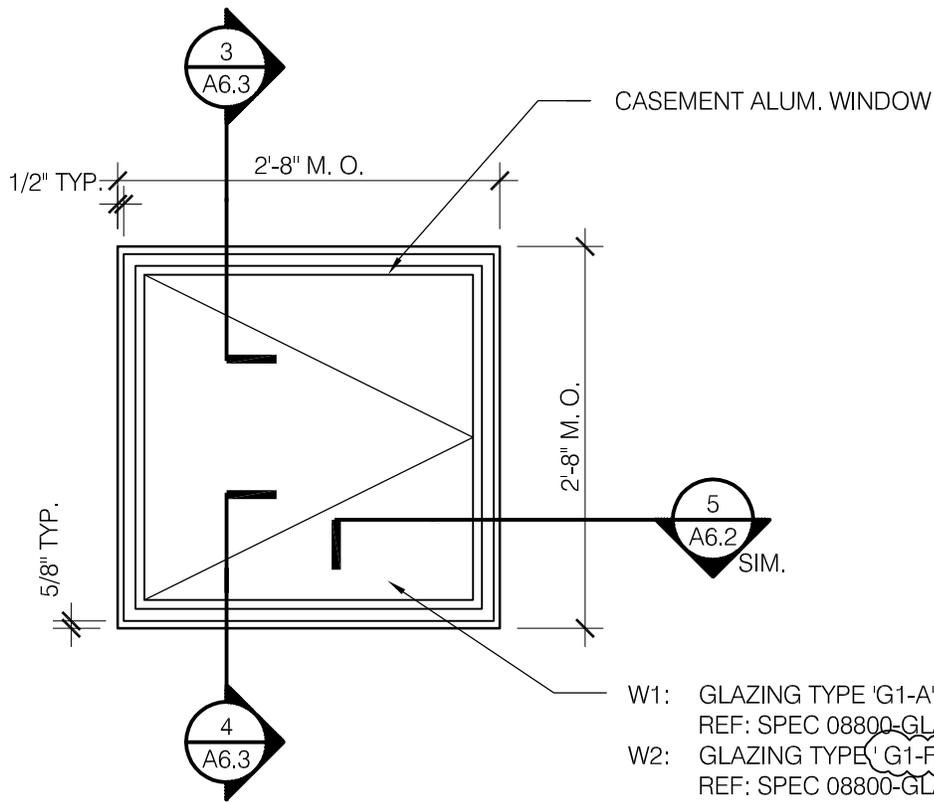
# ALUMINUM WINDOW ELEVATION - TYPE H

3/4" = 1'-0"

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DESCRIPTION:  
 UPDATED WINDOW TYPE

REVISION:  
 ADDENDUM 2

SCALE:  
 AS NOTED  
 DATE:  
 07/02/2010

DRAWN BY:  
 LJH  
 CHECKED BY:  
 KMC

SHEET:  
**ASK.45**  
 REFERENCE:  
**A12.3**

**ROOM FINISH NOTES**

1. ALL WALLS TO RECEIVE PAINT TO FINISH CEILING UNLESS NOTED OTHERWISE
2. BRICK INTERIOR WALLS TO RECEIVE NO BASE.
3. ALL CMU WALLS TO RECEIVE 8" GLAZED CMU BASE UNLESS NOTED OTHERWISE MATCH ASTRA GLAZE - CHARCOAL
4. ALL GYPSUM BOARD WALLS TO RECEIVE RESILIENT BASE UNLESS NOTED OTHERWISE 4. RESILIENT BASE TO MATCH ARMSTRONG COLOR INTEGRATED WALL BASE-94 'MIDNIGHT BLUE'
5. PROVIDE BULLNOSED CERAMIC TILE TRIM AT CERAMIC TILE WALL TRANSITION
6. PROVIDE ANGLE TYPE METAL DIVIDER STRIP- 1/8" DEPTH BY MAN-AM AT FLOOR TRANSITION BETWEEN EPOXY RESIN FLOOR AND OTHER FLOORING
7. PROVIDE 1/4" WHITE ZINC ALLOY DIVIDER STRIP AT TRANSITION OF TERRAZZO FLOOR AND EPOXY RESIN AND OTHER FLOORING
8. ALL INTERIOR HOLLOW METAL DOOR FRAMES TO RECEIVE PAINT MATCHING BENJAMIN MOORE - HC-154 - LOW LUSTRE FINISH
9. ALL INTERIOR HOLLOW METAL DOORS TO RECEIVE PAINT MATCHING BENJAMIN MOORE - 1544- SATIN FINISH
10. ALL EXPOSED CEILINGS TO RECEIVE PAINT MATCHING BENJAMIN MOORE - 1542- FLAT FINISH
11. ALL INTERIOR MISC. METAL TO RECEIVE PAINT MATCHING BENJAMIN MOORE - HC-154- LOW LUSTRE FINISH
12. ALL EXTERIOR HOLLOW METAL DOOR / FRAME AND OVERHEAD DOORS TO RECEIVE PAINT MATCHING BENJAMIN MOORE - 1631- LOW LUSTRE FINISH
13. COORDINATE CONCRETE DECK CONTROL JOINT LOCATION W/ TERRAZZO DIVIDER STRIP AT LOCATION OF CONCRETE DECK CONTROL JOINT PROVIDE 1/8" DOUBLE 'L' DIVIDER STRIP
14. LIMESTONE INTERIOR WALLS TO RECEIVE 8" GLAZED CMU BASE TO MATCH ASTRA GLAZE - SAFARI BEIGE
15. INTERIOR WINDOW SILL TO BE GLAZED CMU TO MATCH ASTRA GLAZE - EGG SHELL
16. ALL JOINTS TO BE TOOLED AT GROUND FACE CMU (INCLUDING UNIT SCORE
17. ALL SHOWERS TO RECEIVE EXPOXY PAINT, EXCEPT SHOWER IN ROOM 205
18. ALL EXTERIOR PLASTER TO RECEIVE PAINT MATCHING BENJAMIN MOORE - SUPER WHITE
19. ALL PLUMBING ACCESS DOORS & FRAMES IN THE CELL CORRIDOR TO RECEIVE PAINT MATCHING BENJAMIN MOORE - HC- 154 LOW LUSTRE FINISH
20. ALL EXTERIOR BOLLARDS TO RECEIVE PAINT MATCHING BENJAMIN MOORE - HC 154- LOW LUSTRE FINISH. ALL DECORATIVE BOLLARDS AND ENTRANCE CANOPY TO RECEIVE PAINT MATCHING BENJAMIN MOORE - HC 154- HIGH GLOSS FINISH.
21. ALL BENCHES & CEILING IN THE DETENTION, HOLDING, & CELLS AREAS TO RECEIVE PAINT MATCHING BENJAMIN MOORE -1544 - SEMI GLOSS FINISH
22. ALL GYPSUM BOARD SOFFITS TO RECEIVE PAINT MATCHING BENJAMIN MOORE - SUPER WHITE, SATIN FINISH
23. REFERENCE CEILING PLANS A2.1 & A2.2 AS NEEDED
24. ALL CMU LOW HEIGHT WALLS ARE TO BE BULLNOSE AT ALL HORIZONTAL & VERTICAL EDGES.
25. ALL METAL SECURITY CEILING TO RECIEVE PAINT MATCHING BENJAMIN MOORE - SUPER WHITE (COMPLETE PAINTING AFTER CEILING HAS BEEN WELDED)
26. TRANSITION TERRAZZO AND RESINOUS FLOORING AS INDICATED ON DETAIL 11/A10.2
27. BUILDING ELEVATIONS ARE TO TOP OF SLAB, FINISHES MAY VARY IN THICKNESS AND ARE TO MATCH IN HEIGHT
28. IN ROOMS 224 AND 221A COMPUTER SUPPORT ROOMS PROVIDE A PLACARD MAP WITH DIMENSIONS INDICATING THE GROUND CONDUCTOR INSTALLATION LOCATION BELOW THE FLOORING
29. ALL EXPOSED GAS PIPING IN ALL MECHANICAL ROOMS 125, 126 AND 216 TO BE PAINTED YELLOW
30. IN ROOMS 167, 168, 173 AND 149 PROVIDE GLAZED CMU WAINSCOAT FROM FLOOR TO EL. = 104'-0", PROVIDE EPOXY PAINT ABOVE
31. ALL NON-POTABLE WATER PIPING AND INSULATION TO BE PAINTED YELLOW.

2

2

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 1412 SOUTH BLUE ISLAND AVENUE, CHICAGO, IL 60608

DESCRIPTION: UPDATED ROOM FINISH NOTES

REVISION: ADDENDUM 2

SCALE: N.T.S.

DATE: 07/02/2010



DRAWN BY: LJH

CHECKED BY: KMC

SHEET: **ASK.46**

REFERENCE: 1/A13.1-2

FILE: U:\2443n-00 12th District Police Station\Drawings\Sheets\ASKs\ASK47.dwg

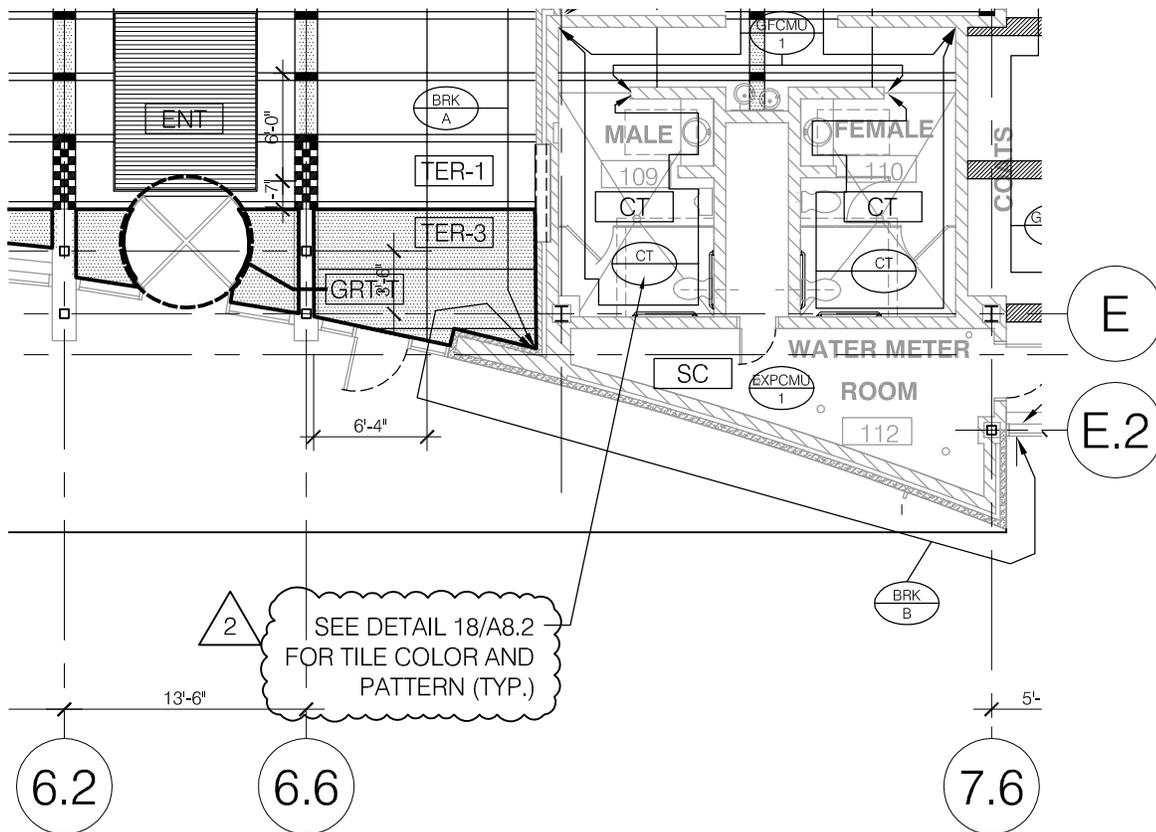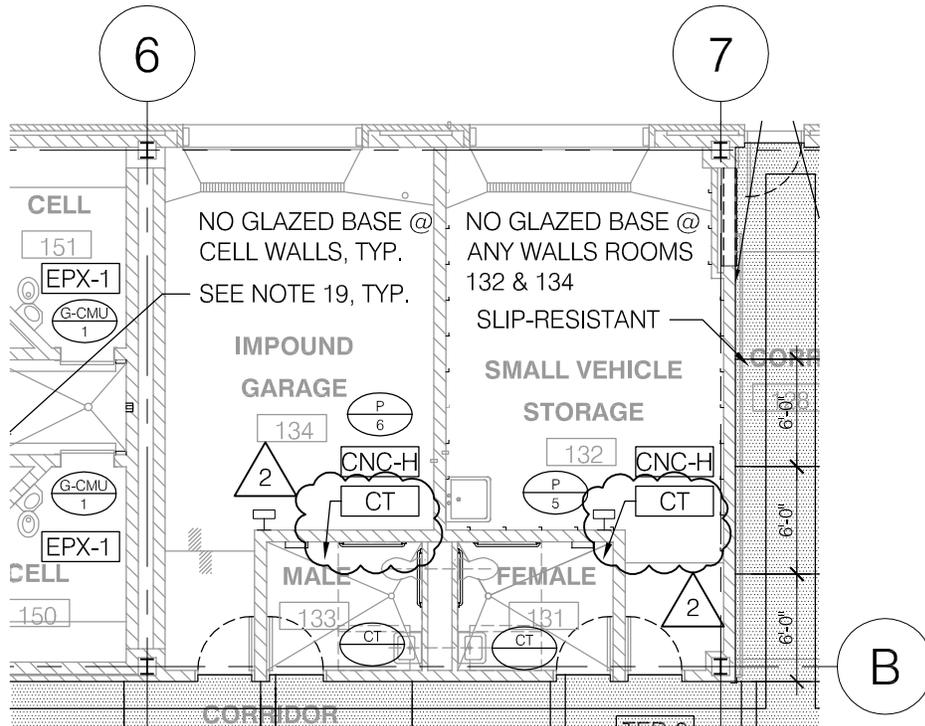

**1ST. FLR. ROOM FINISH PLAN**

1  
A13.1

3/32" = 1/20"


2



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	<p>DESCRIPTION: UPDATED ROOM FINISH PLAN</p>	<p>REVISION: ADDENDUM 2</p>	<p>DATE: 07/02/2010</p>	<p>CHECKED BY: KMC</p>	<p>REFERENCE: <b>A13.1</b></p>

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2ND FLR. ROOM FINISH PLAN

1  
A13.2  
3/32" = 1'-0"
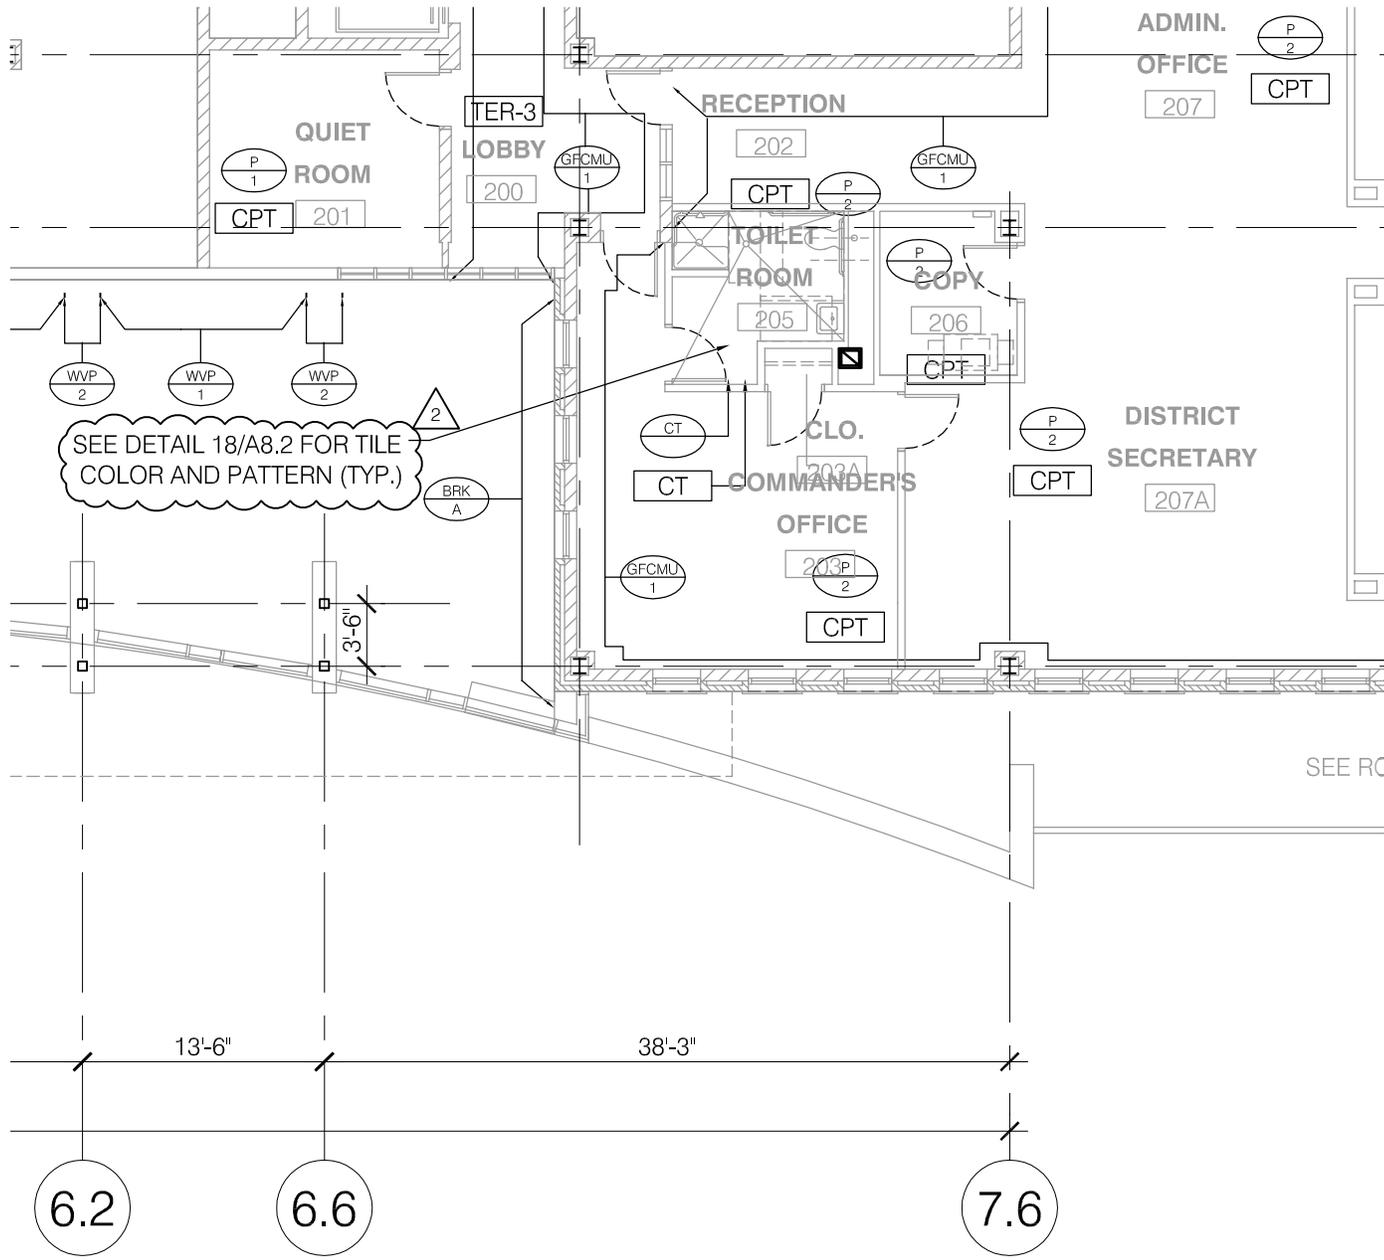
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	<p>DESCRIPTION: UPDATED ROOM FINISH PLAN</p>	<p>REVISION: ADDENDUM 2</p>	<p>DATE: 07/02/2010</p>	<p>CHECKED BY: KMC</p>	<p>REFERENCE: A13.2</p>

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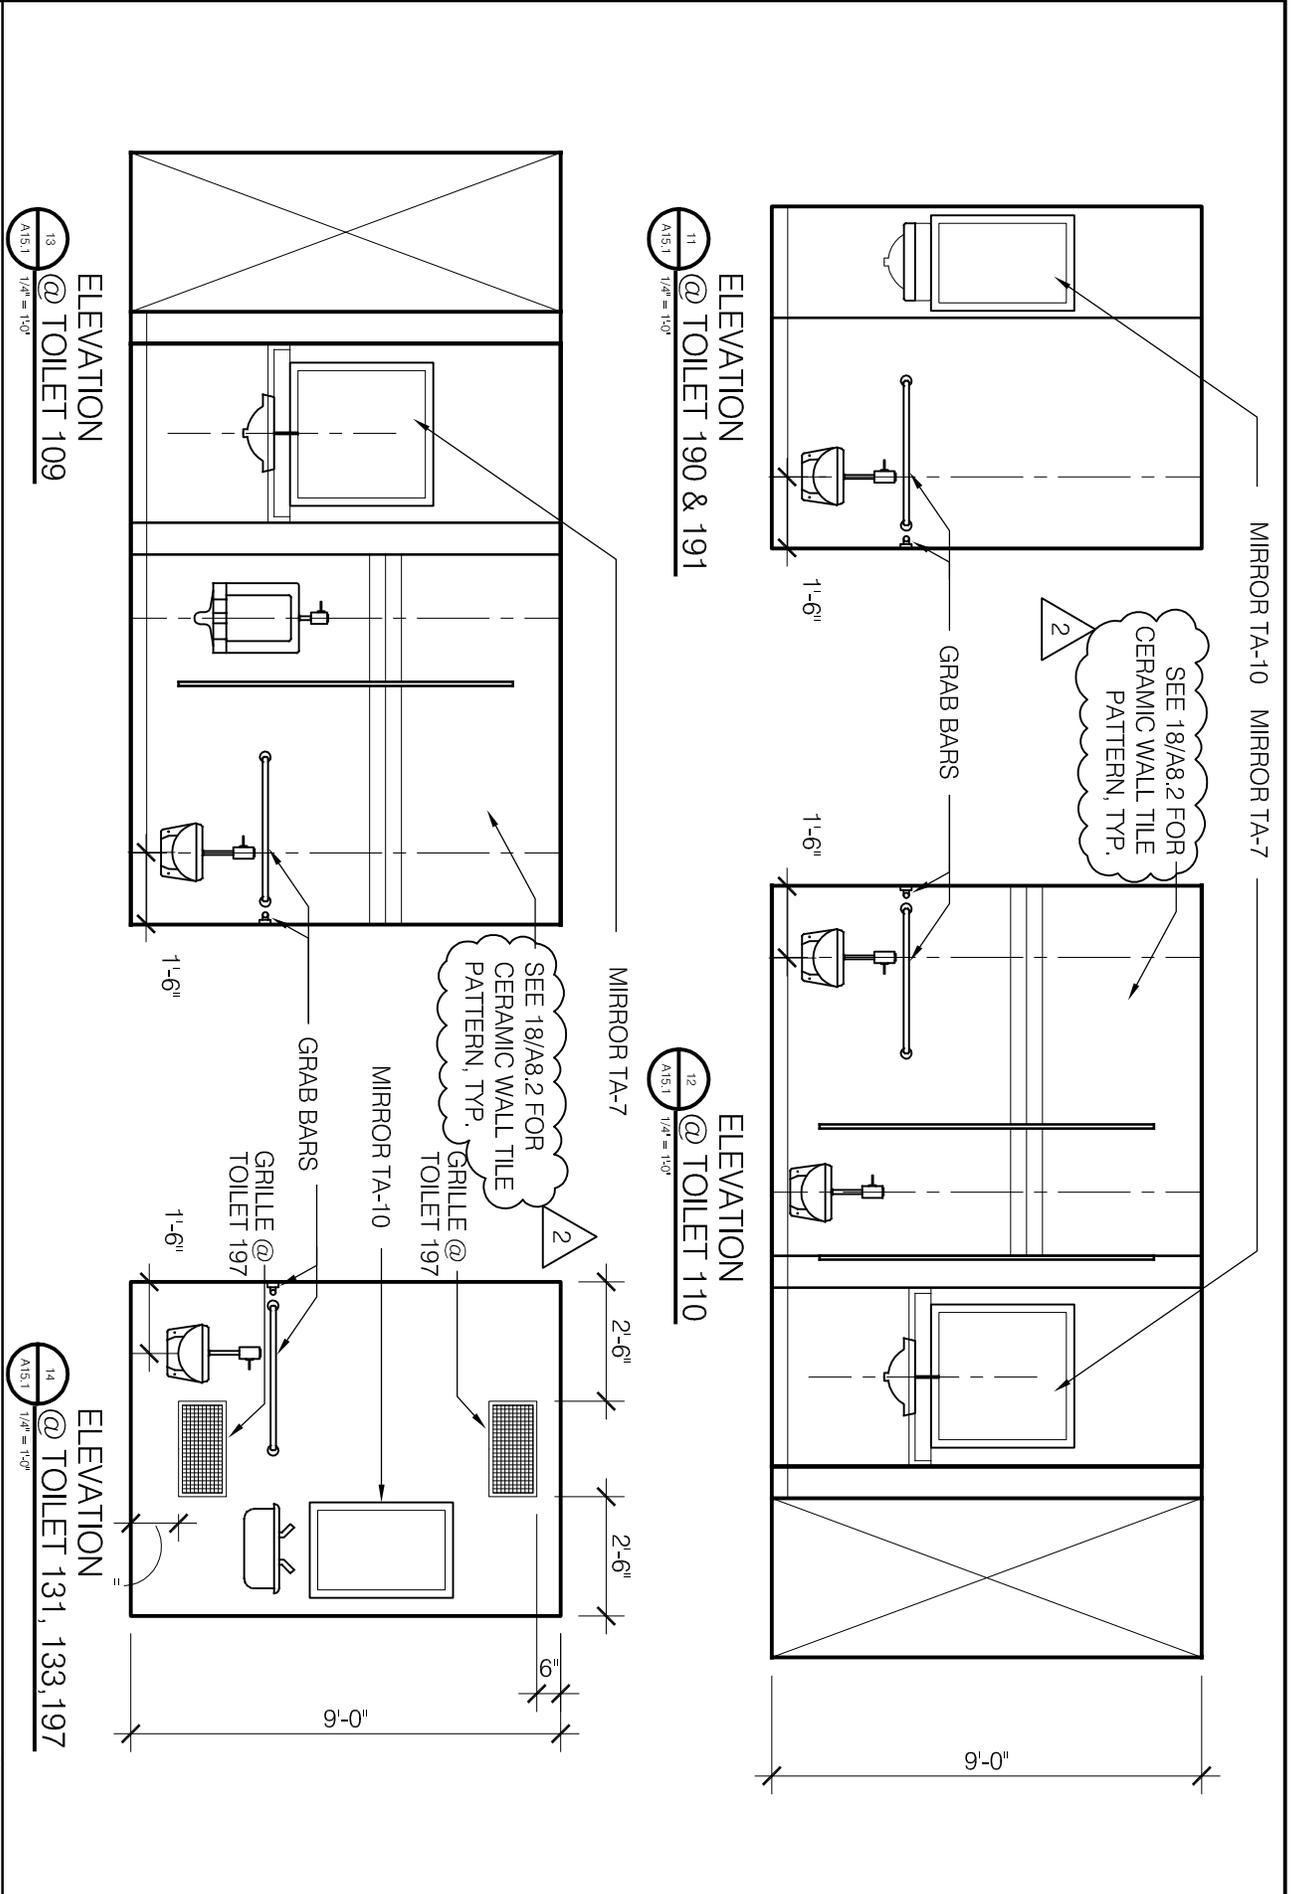
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SCALE: AS NOTED

DATE: 07/02/2010

SHEET: **ASK.49**  
 REFERENCE: A15.1



DESCRIPTION:  
 UPDATED TOILET ROOM ELEVATIONS

REVISION:  
 ISSUED FOR ADDENDUM 2

DRAWN BY: LJH  
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Plot Date: 10/17/2008



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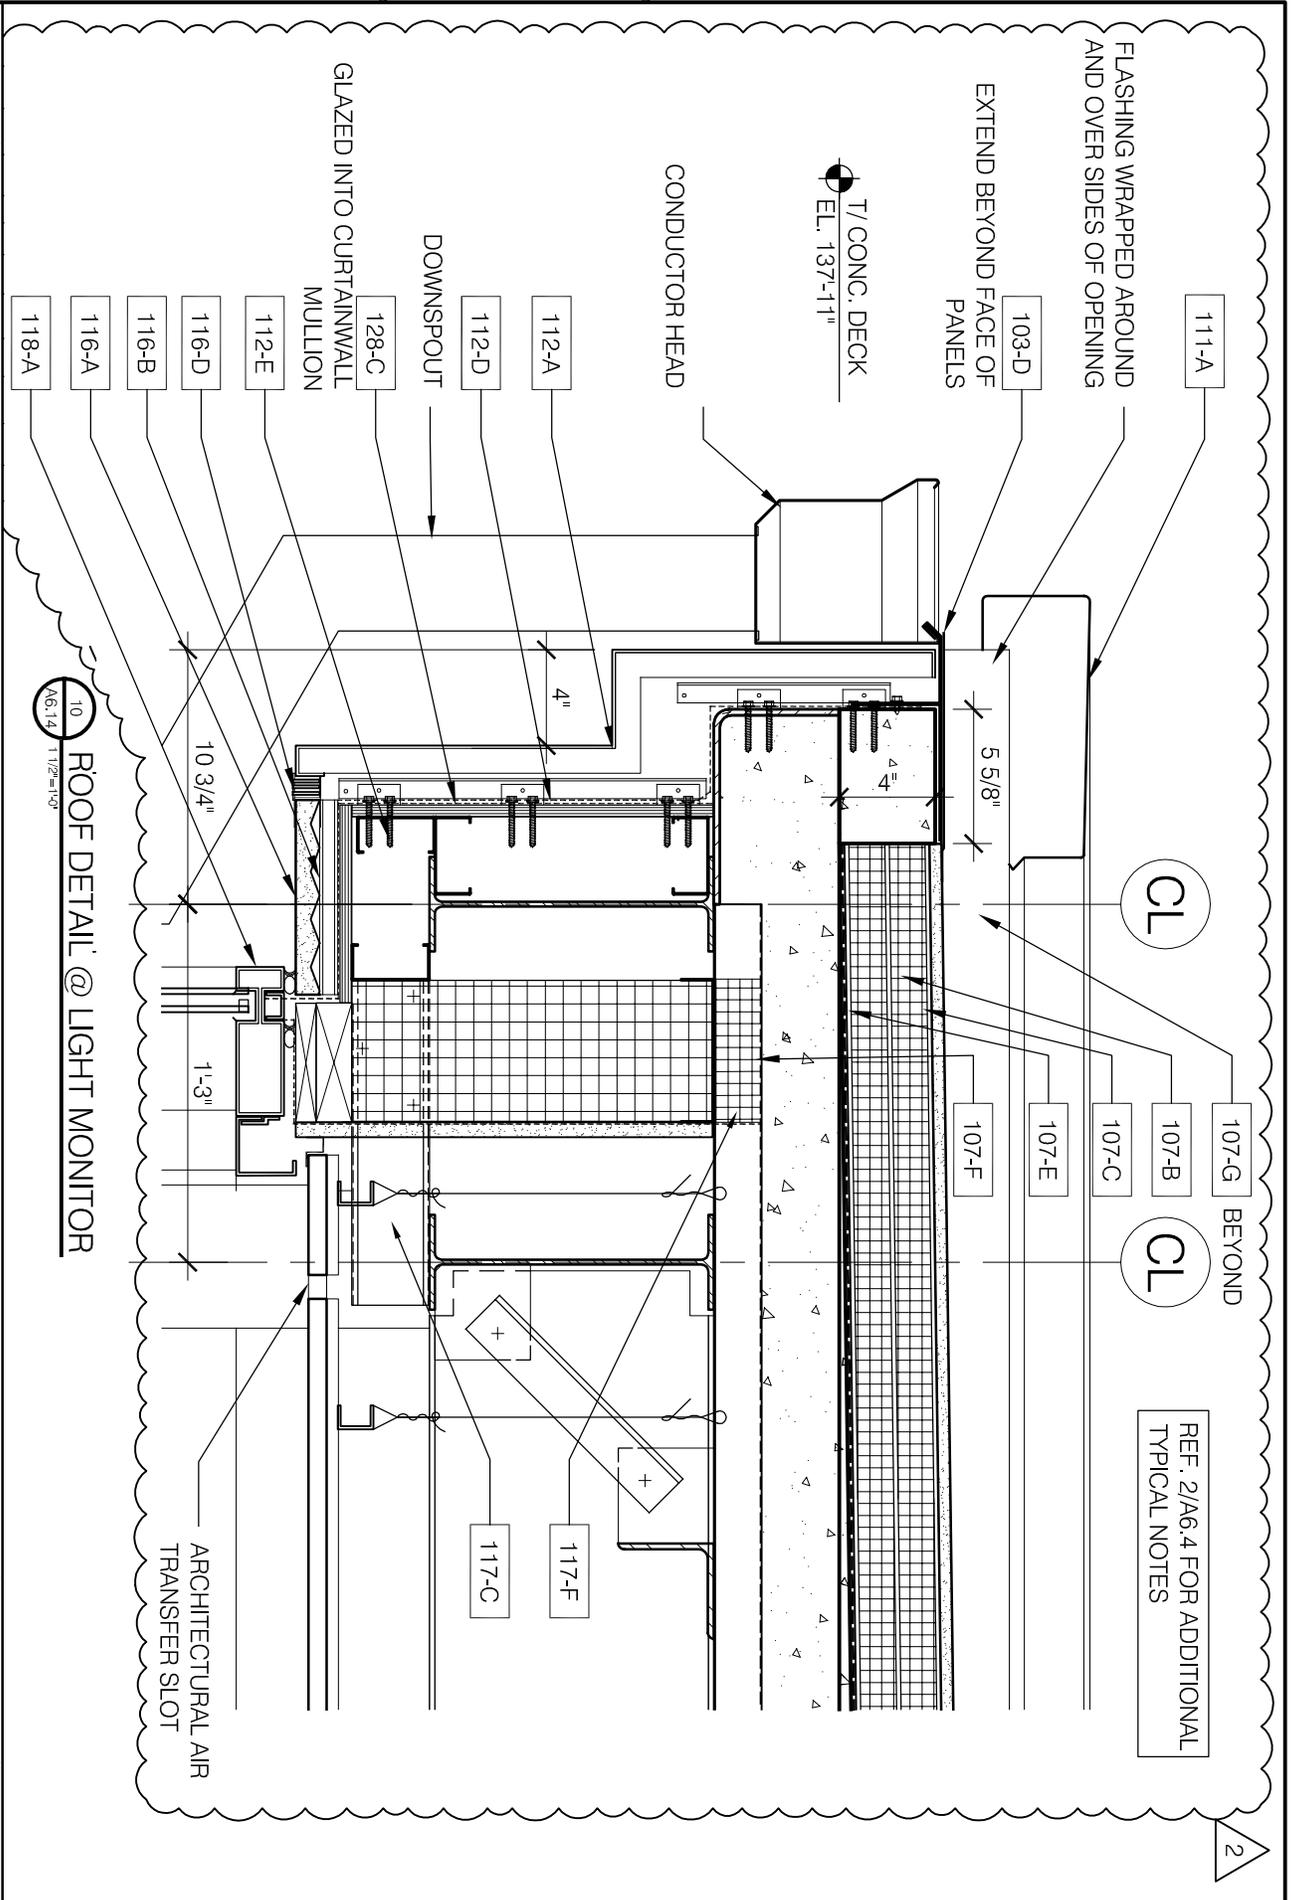
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SCALE: AS NOTED  
 DATE: 07/02/2010  
 DRAWN BY: LJH  
 CHECKED BY: KMC

DESCRIPTION: UPDATED LIGHT MONITOR DETAIL  
 REVISION: ISSUED FOR ADDENDUM 2

SHEET: **ASK.50**  
 REFERENCE: **A6.14**



**10 ROOF DETAIL @ LIGHT MONITOR**  
 A6.14 1/12" = 1'-0"

Plot Date: 10/17/2008



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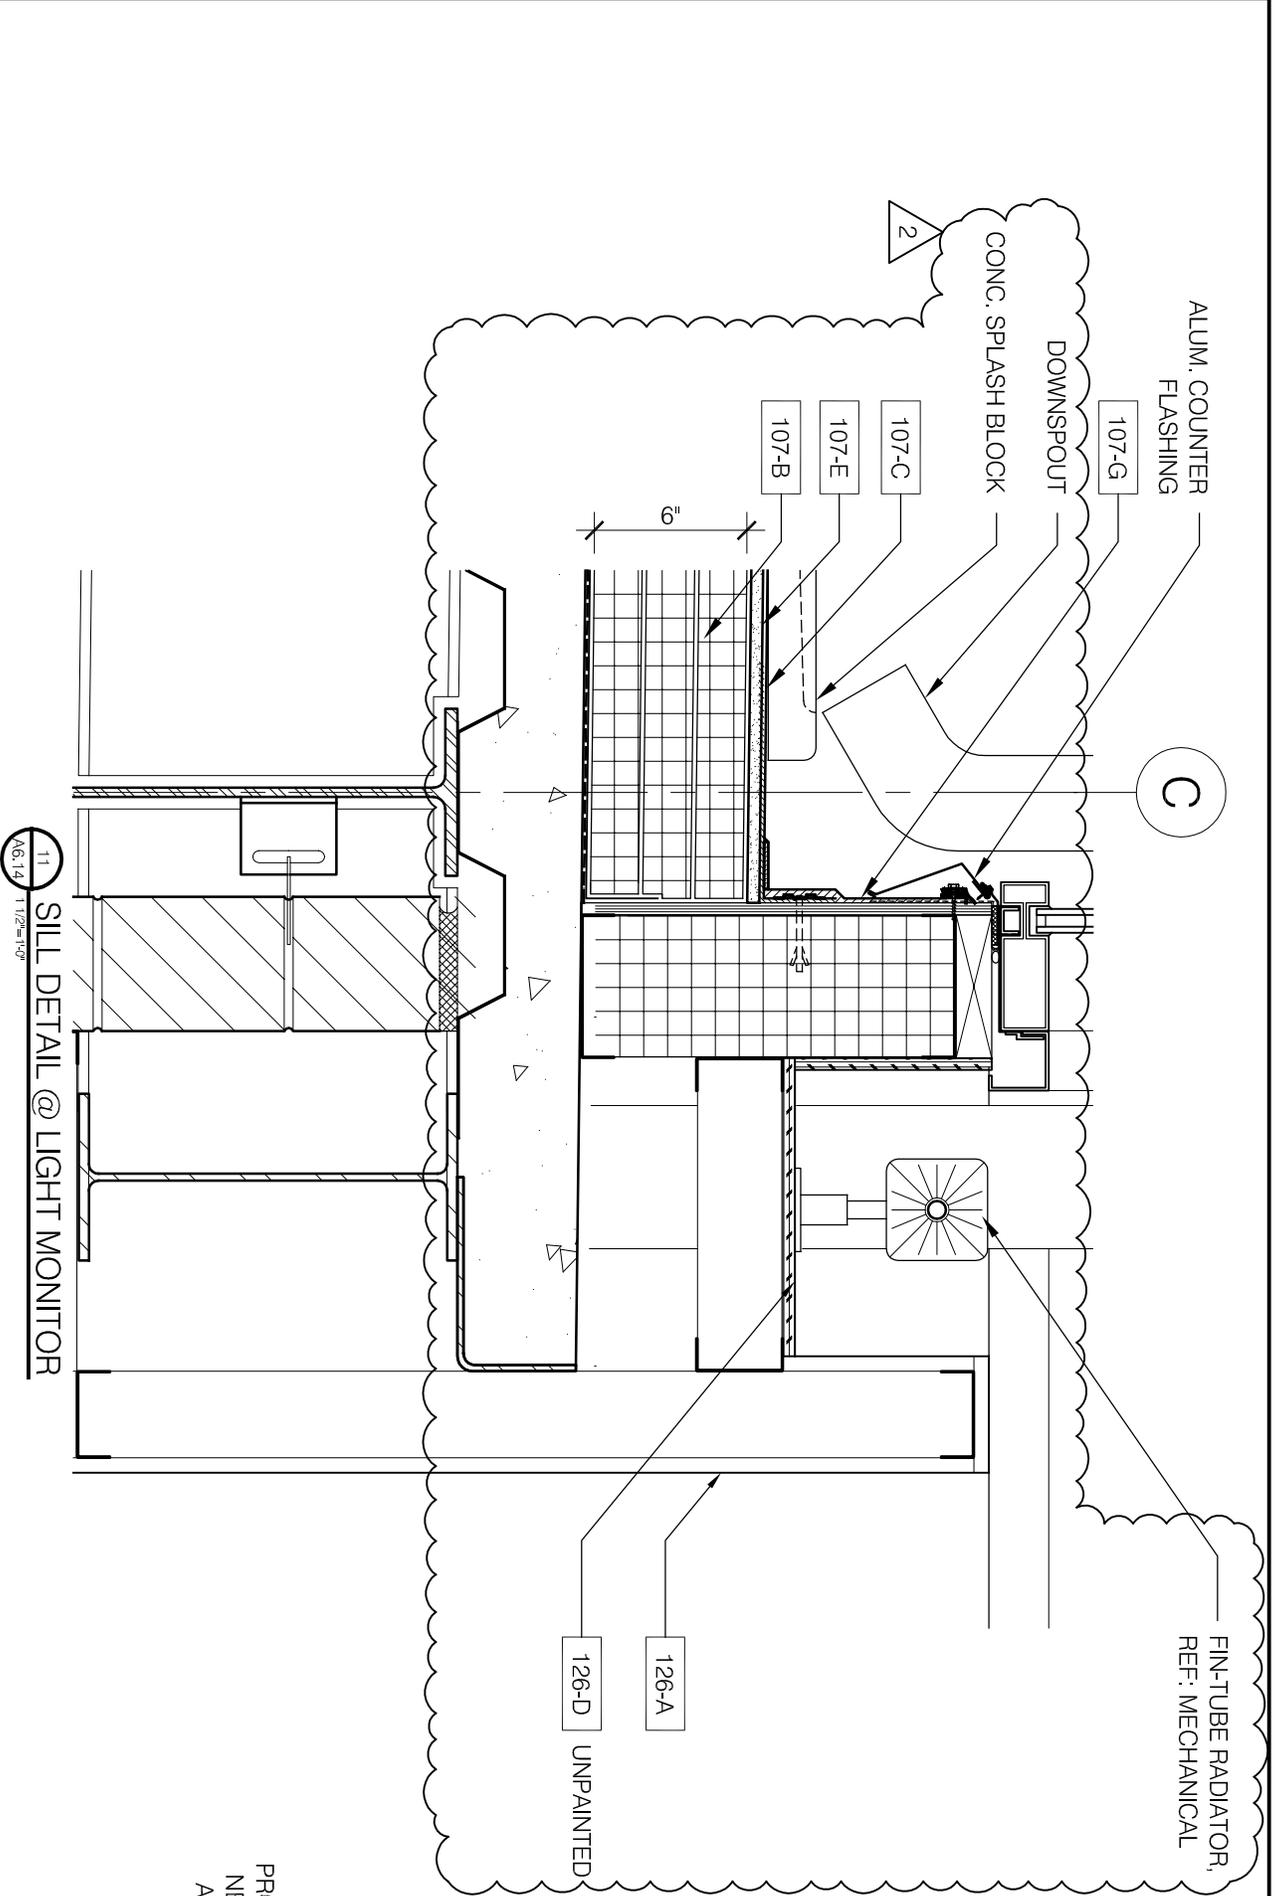
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SCALE: AS NOTED  
 DATE: 07/02/2010

DRAWN BY: LJH  
 CHECKED BY: KMC

SHEET: **ASK.51**  
 REFERENCE: A6.14



PRO  
 NE  
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Plot Date: 10/17/2008



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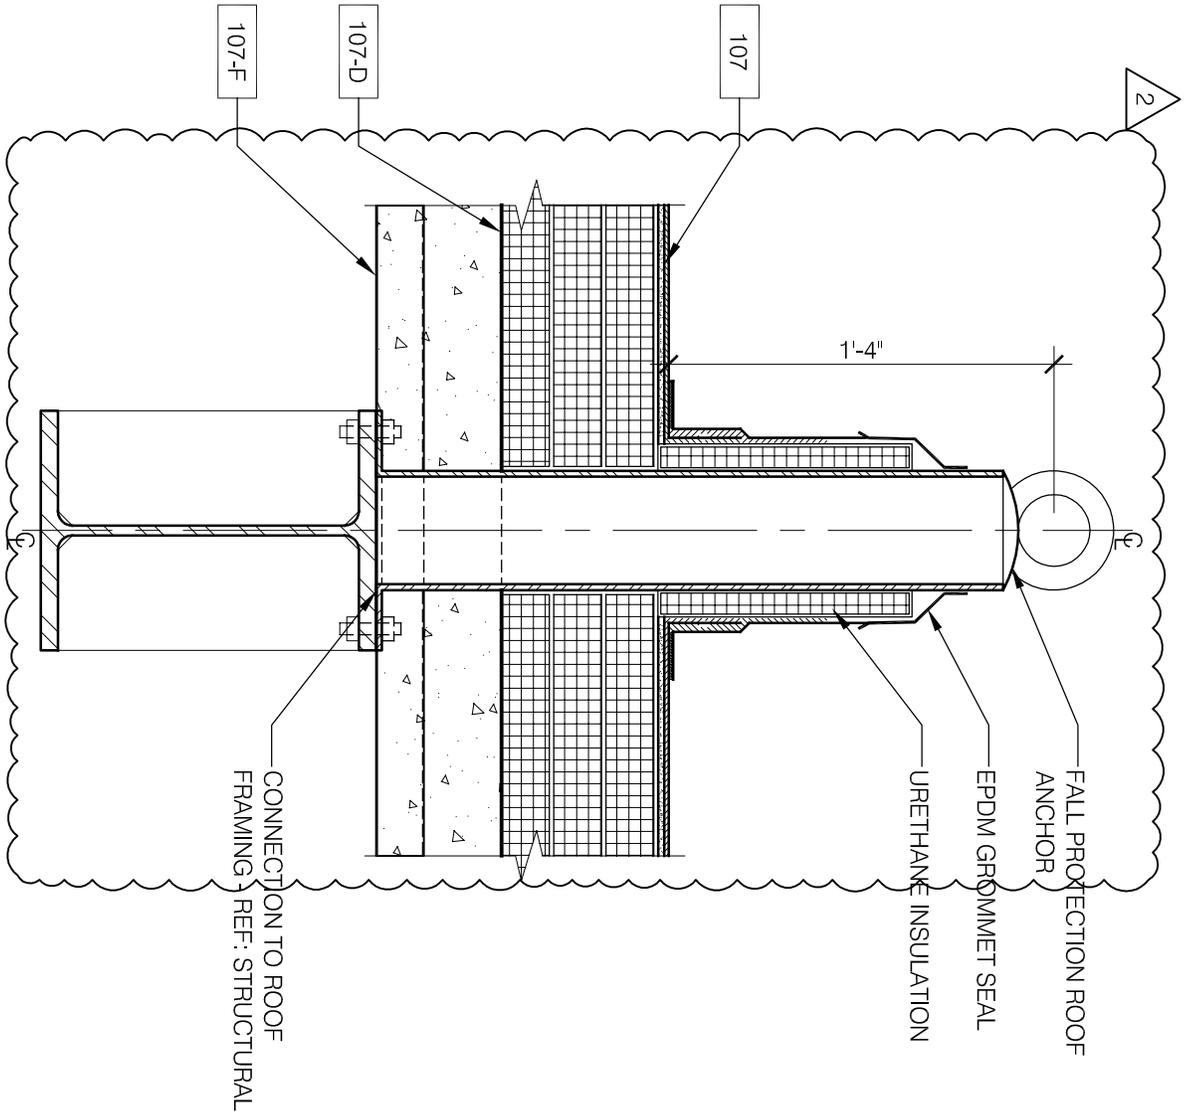
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SCALE: AS NOTED  
 DATE: 07/02/2010

DRAWN BY: LJH  
 CHECKED BY: KMC

SHEET: **ASK.52**  
 REFERENCE: A6.14

**9 ROOF ANCHOR DETAIL**  
 A6.14 1/12"=1'-0"



GENERAL NOTES:

1. FOR GRADING AND ELEVATION INFORMATION PLEASE SEE CIVIL DRAWINGS.
2. SEE SHEET L1.2 FOR LANDSCAPE DETAILS.
3. CONTRACTOR TO REFER TO HARDSCAPE & SITE FURNISHING PLAN L3.1, NOT THE CIVIL DRAWINGS, FOR CONFIGURATION OF THE SCORING PATTERNS AT ALL SIDEWALK AREAS AND FOR SITE FURNISHING LOCATIONS.
4. CONTRACTOR TO REFER TO THE ARCHITECTURAL DRAWINGS FOR THE FINAL CONFIGURATION OF THE PLAZA AREAS.
5. CONTRACTOR TO REFER TO THE CIVIL DRAWINGS FOR THE SCORING PATTERN OF VEHICULAR CONCRETE PAVING AT ALLEY AND PARKING LOT PAVERS.
6. SEE SURVEY FOR EXISTING SITE INFORMATION.
7. MULCH ALL PLANT BEDS AFTER PLANTING WITH 3" LAYER SHREDDED HARDWOOD BARK MULCH.
8. NO GROWTH OVER 12" WITHIN SITE TRIANGLE.
9. LANDSCAPE REMOVAL AND TREE PROTECTION PLAN AND DETAILS WILL BE ADDED ONCE EXISTING TREE INFORMATION IS MADE AVAILABLE.
10. REMOVE EXISTING BELOW-GRADE OBSTRUCTIONS AS REQUIRED FOR THE COMPLETION OF LANDSCAPING, COORDINATE REMOVAL OF EXISTING OBSTRUCTIONS WITH SPECIFICATION SECTION "SITE CLEARING" AND APPROPRIATE SECTIONS OF THE CONTRACT DOCUMENTS FOR THE NEW WORK.

11. CONTRACTOR SHALL RECYCLE CLEAN CONSTRUCTION DEBRIS IN ACCORDANCE WITH SPECIFICATION SECTION 01524 AND AS PERMITTED BY SPECIFICATION SECTION 02316.

2

12. ALL SOILS AND CONSTRUCTION & DEMOLITION DEBRIS SHALL BE HANDLED IN ACCORDANCE WITH ENVIRONMENTAL REQUIREMENTS. REFER TO SPECIFICATION SECTION 02316.

2

13. THE CONTRACTOR SHALL EXCAVATE, REMOVE, AND DISPOSE OF SOILS (INCLUDING NON-SPECIAL WASTE SOILS AND NON-HAZARDOUS SPECIAL WASTE SOILS), FILL, BACKFILL, TOPSOIL, CU STRUCTURAL SOIL, AND GENERAL CONSTRUCTION AND DEMOLITION DEBRIS TO DEPTHS REQUIRED TO COMPLETE THE LANDSCAPING WORK ACTIVITIES AS SPECIFIED IN THE ARCHITECT/ENGINEERING DRAWINGS AND SPECIFICATIONS.

14. NATIVE CLAY MATERIALS OBTAINED FROM 20 FEET BELOW 13.17' CHICAGO CITY DATUM AND (WITH THE EXCEPTION OF AREA D SHOWN ON DRAWING ENV.1 MAY BE USED ONSITE IN ACCORDANCE WITH CONTRACT SPECIFICATIONS OR CAN BE SENT TO AN OPEN, ACTIVE, AND PERMITTED CCDD OPERATION FACILITY IN ACCORDANCE WITH SPECIFICATION SECTION 02316.

2

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 1412 SOUTH BLUE ISLAND AVENUE, CHICAGO, IL 60608

DESCRIPTION:  
 UPDATED GENERAL NOTES

REVISION:  
 ADDENDUM 2

SCALE:  
 N.T.S.




DATE:  
 07/02/2010

DRAWN BY:  
 LJH

CHECKED BY:  
 KMC

SHEET:  
**ASK.53**

REFERENCE:  
**L1.1**

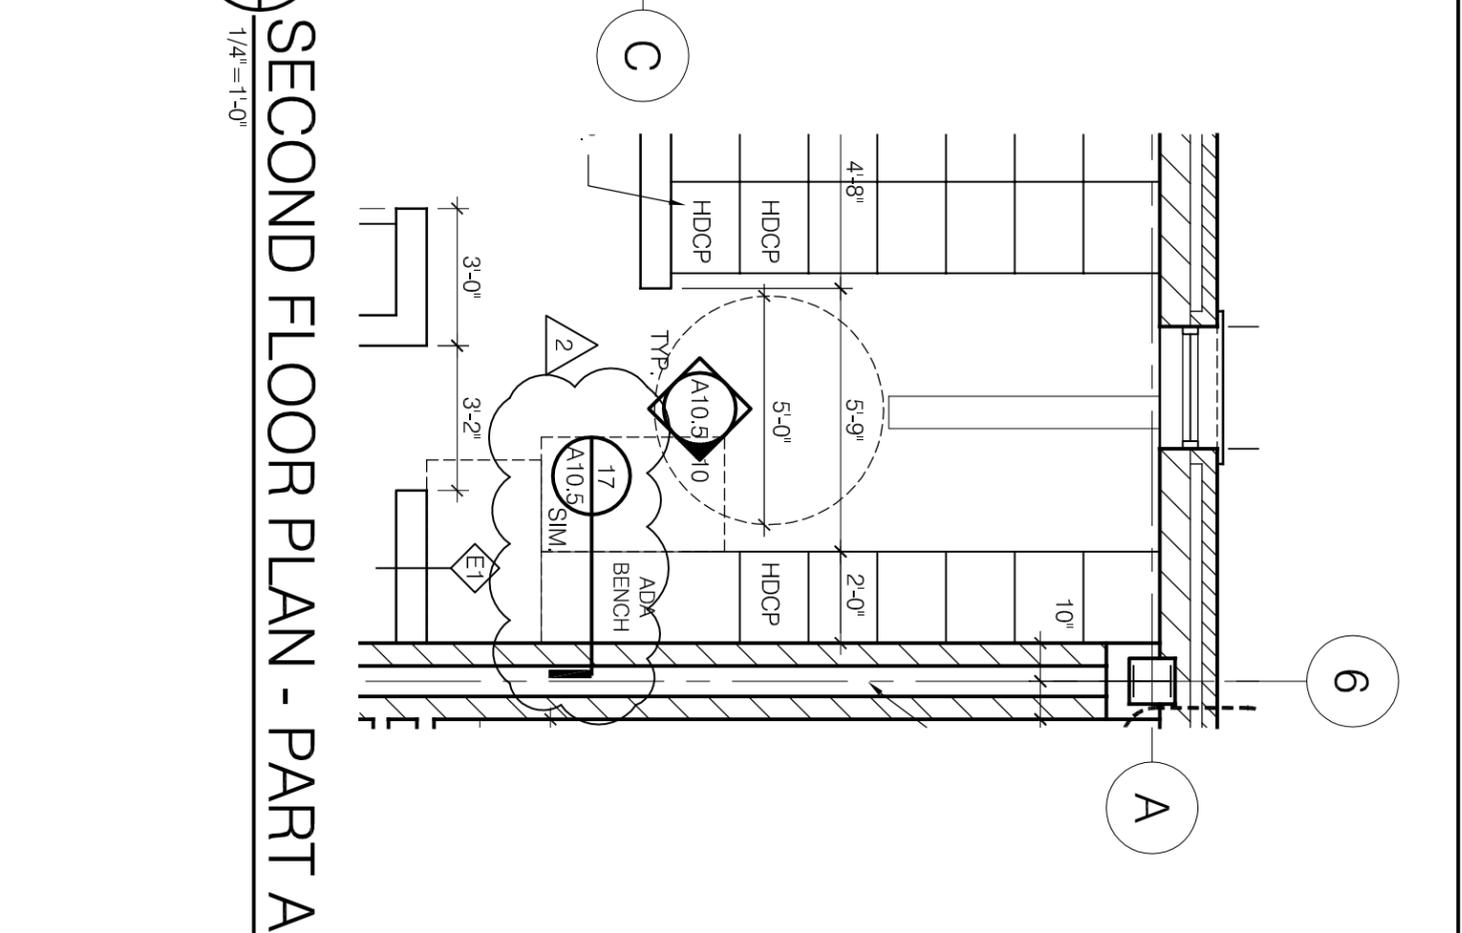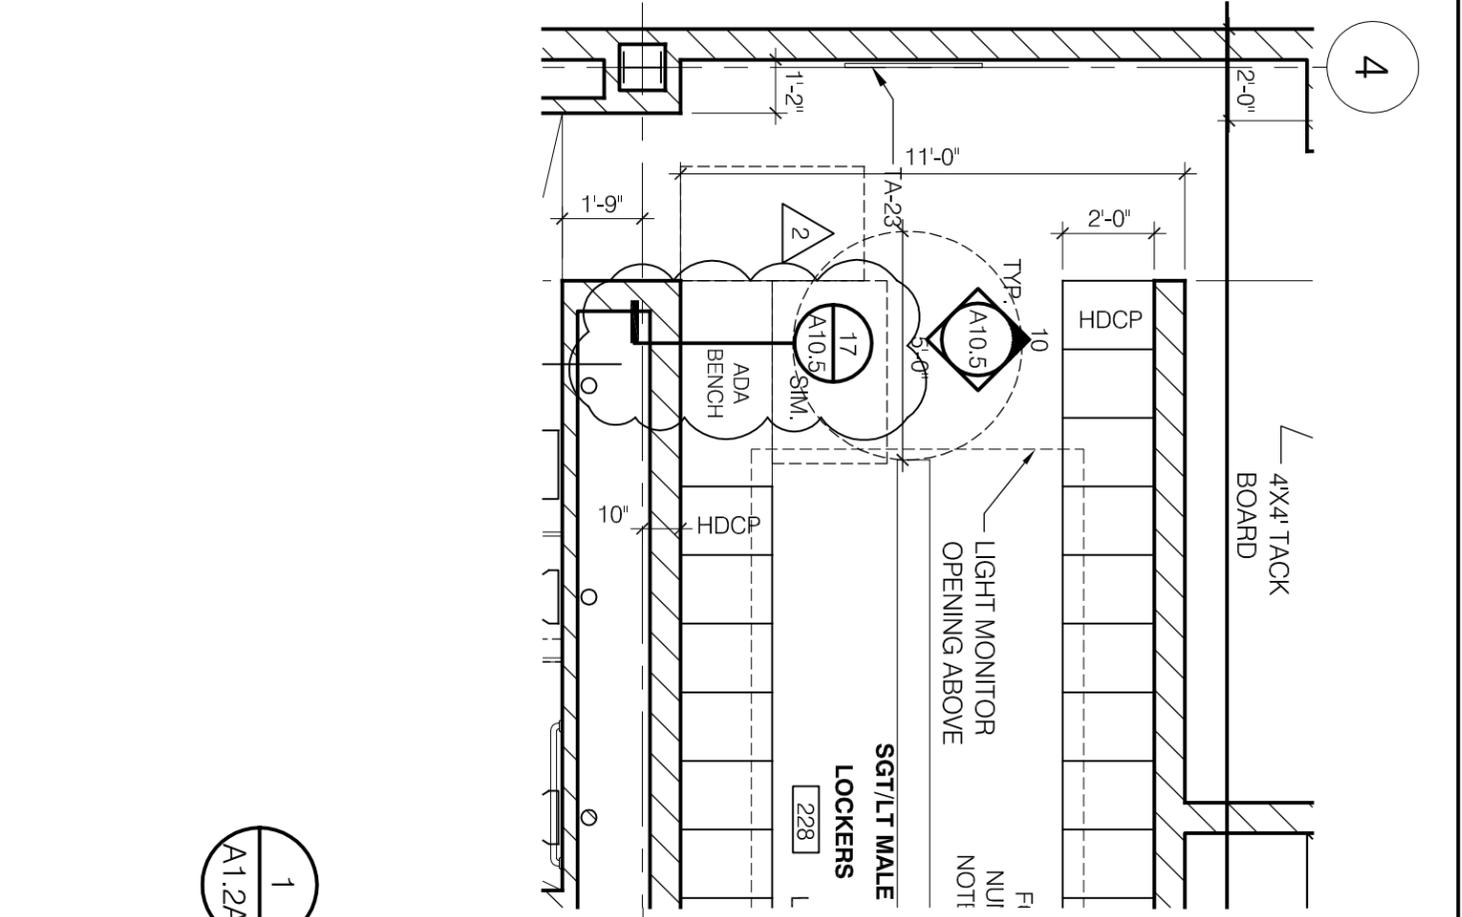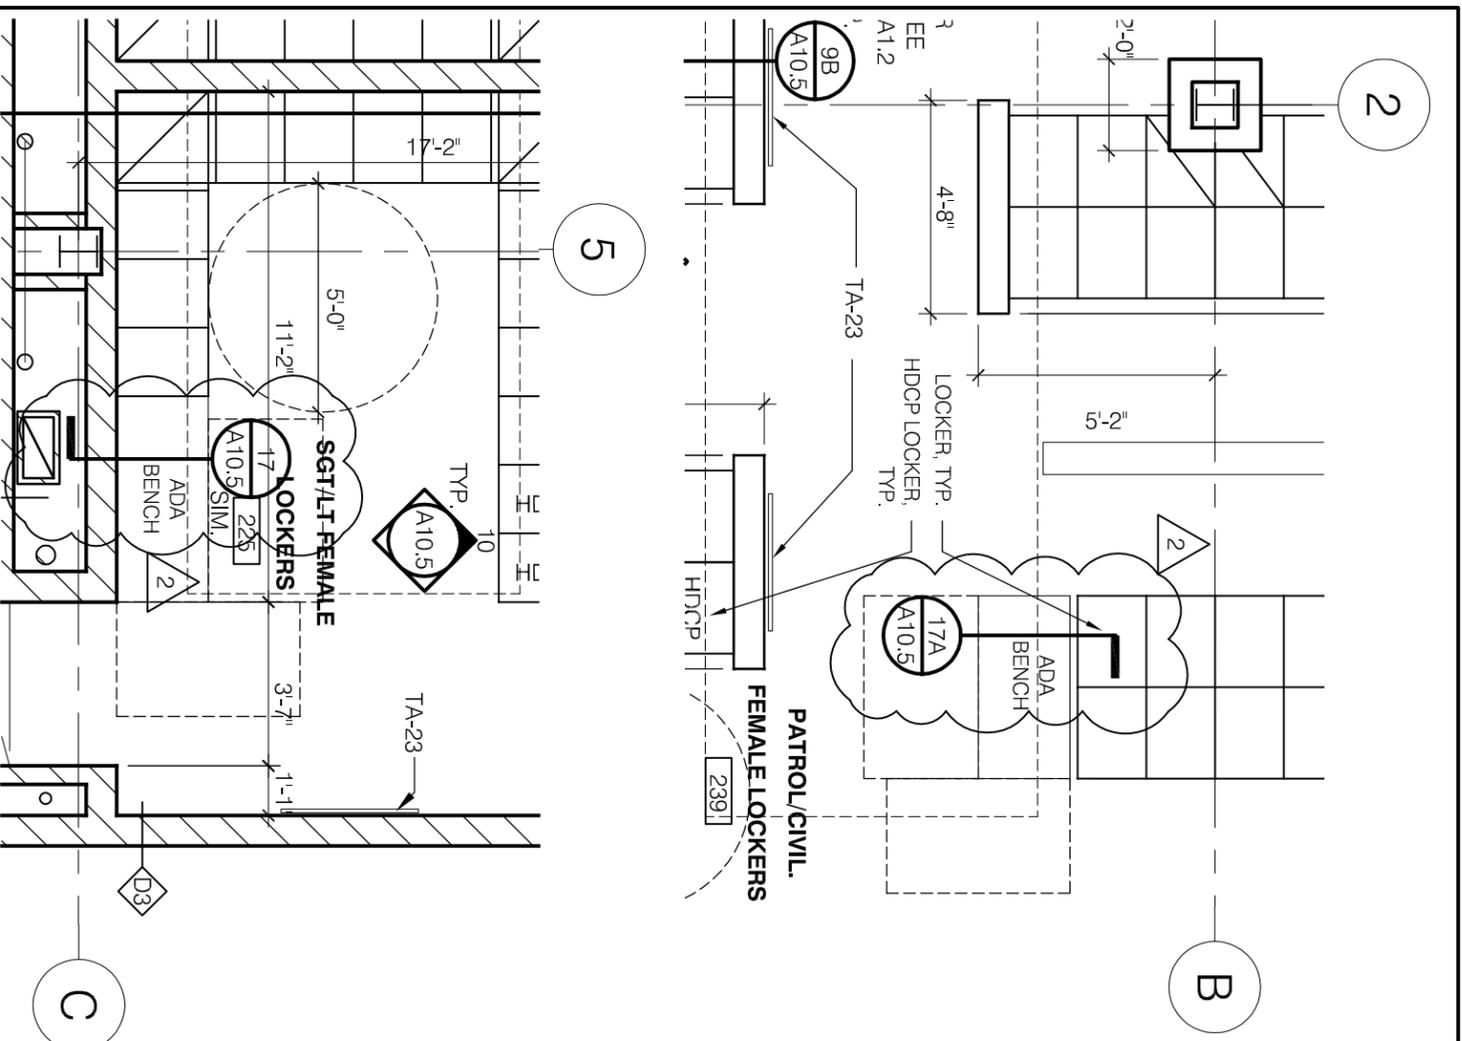

1 SECOND FLOOR PLAN - PART C  
A1.2C 1/4"=1'-0"

1 SECOND FLOOR PLAN - PART A  
A1.2A 1/4"=1'-0"



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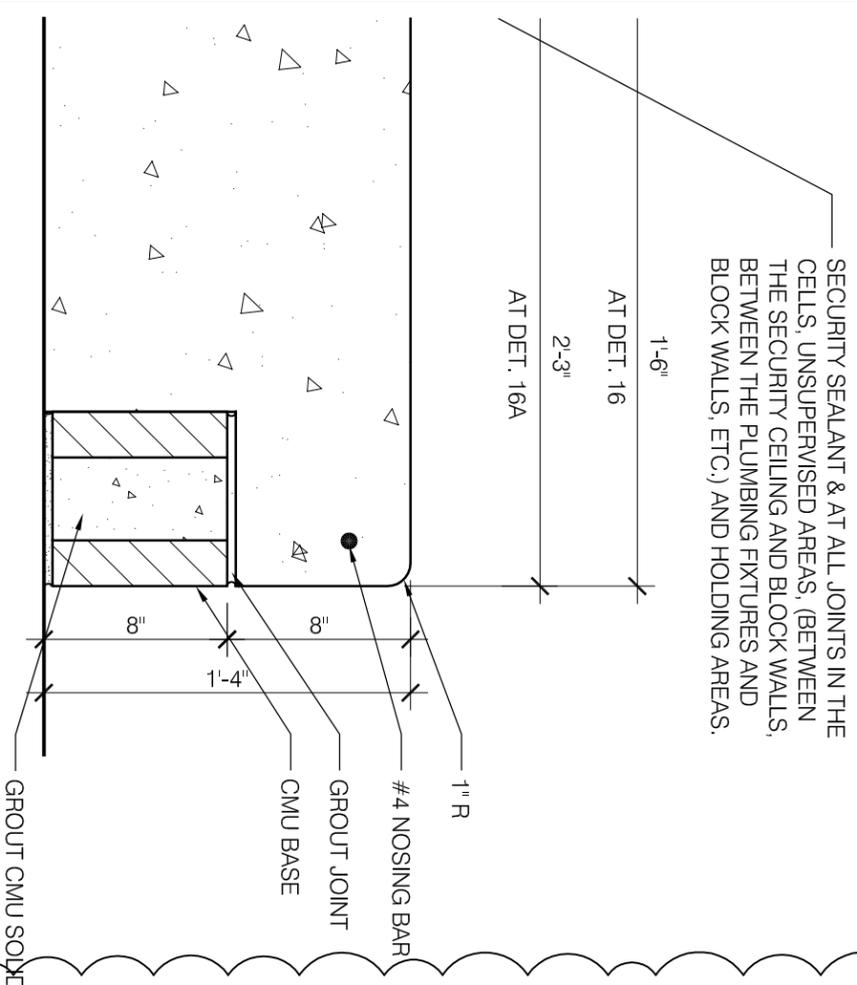
DESCRIPTION:	DRAWN BY:	SCALE:	SHEET:
UPDATED SECOND FLOOR PLAN	LH	AS NOTED	<b>ASK.54</b>
REVISION:	CHECKED BY:	DATE:	REFERENCE:
ADDENDUM 2	KMC	07/09/2010	<b>A1.2A,C</b>

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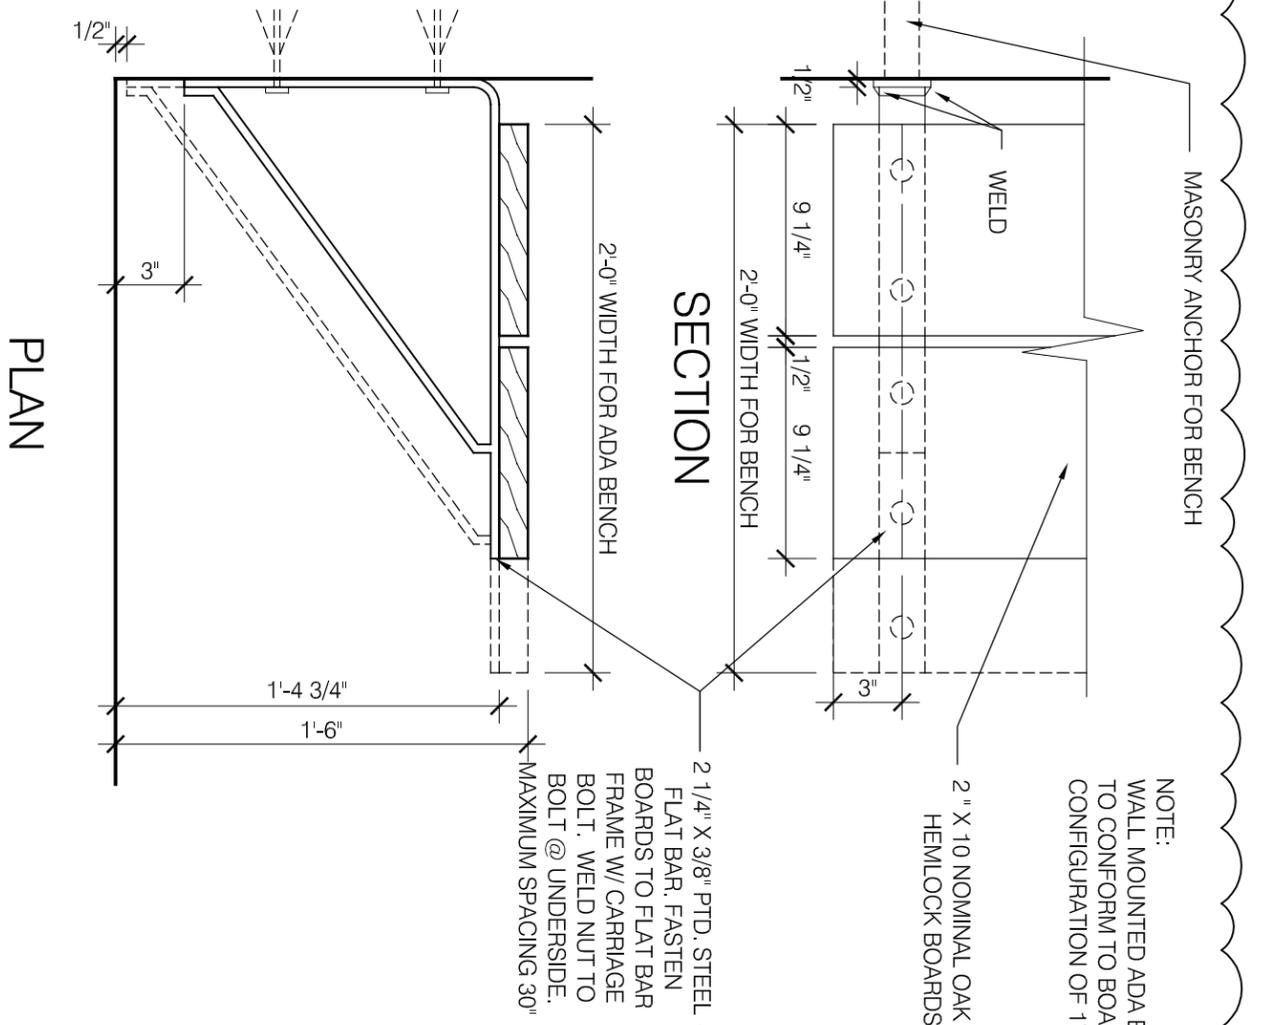
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 CHICAGO, IL 60608

DESCRIPTION: UPDATED BENCH DETAILS	DRAWN BY: LJH	SCALE: AS NOTED	SHEET: <b>ASK.55</b>
REVISION: ADDENDUM 2	CHECKED BY: KMC	DATE: 07/09/2010	REFERENCE: <b>A10.5</b>


16A  
 A10.5  
 1 1/2" = 1'-0"  
**DETAIL @ CONC. BENCH**



17  
 A10.5  
 1 1/2" = 1'-0"  
**WALL MTD. BENCH DETAIL**



17A  
 A10.5  
 1 1/2" = 1'-0"  
**FLOOR MTD. BENCH DETAIL**

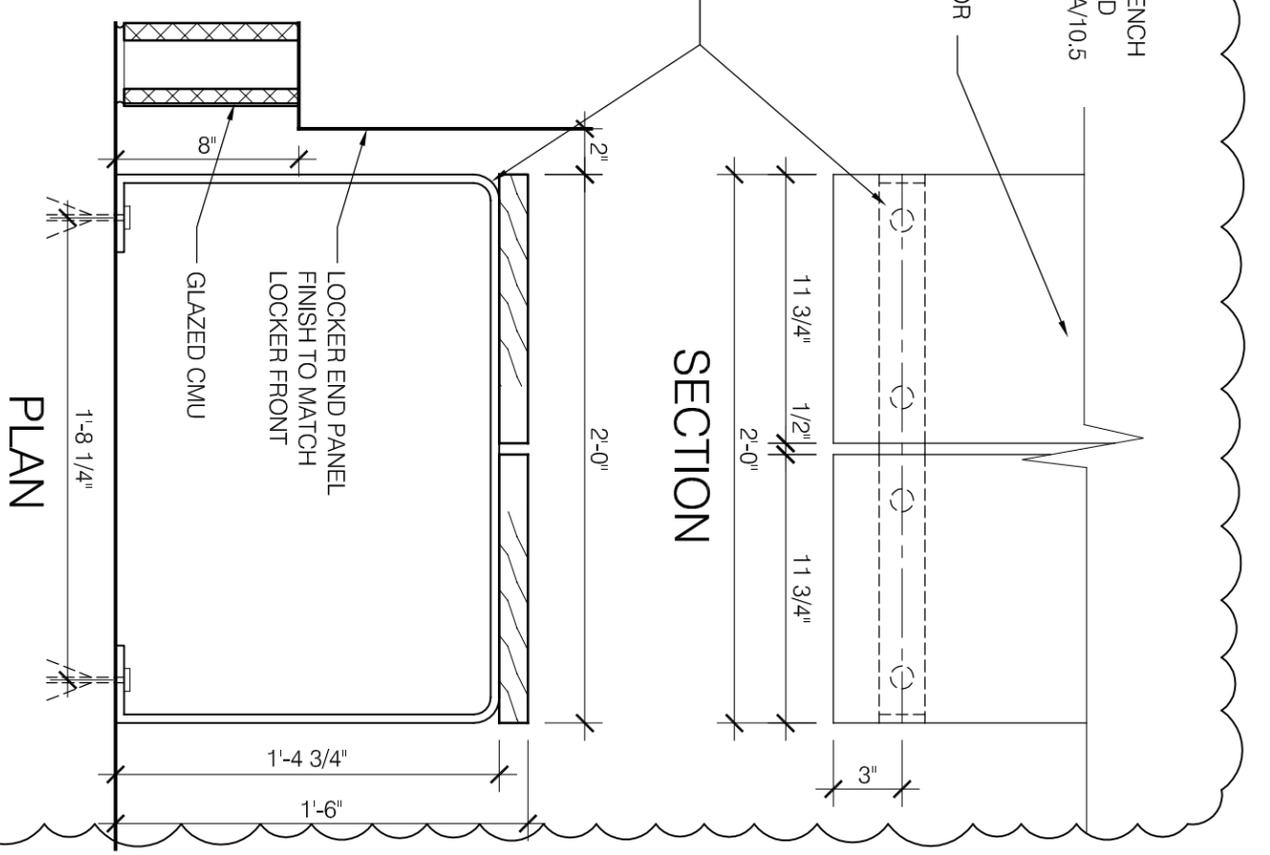

Plot Date: 10/17/2008



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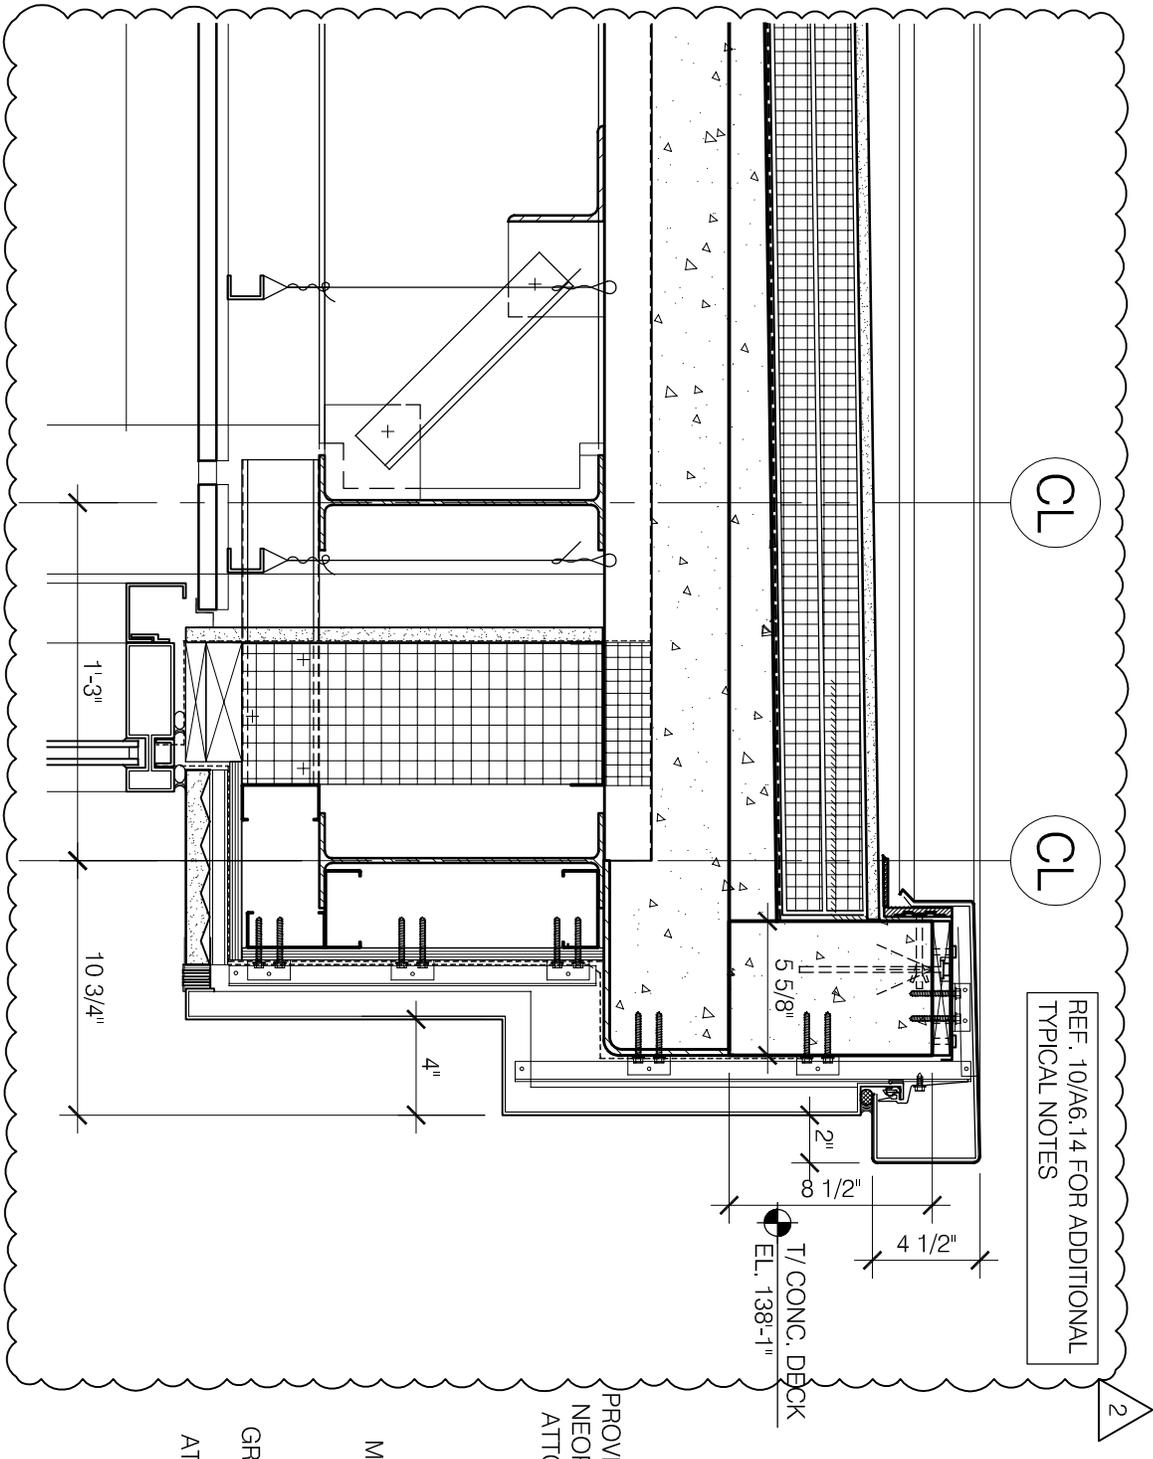
**12th DISTRICT POLICE STATION**  
 1412 SOUTH BLUE ISLAND AVENUE  
 CHICAGO, IL 60608

SCALE: AS NOTED

DRAWN BY: LJH  
 CHECKED BY: KMC

SHEET: **ASK.56**  
 REFERENCE: A6.14

**10A A6.14 1/12=1/8" ROOF DETAIL @ LIGHT MONITOR**




REF. 10/A6.14 FOR ADDITIONAL TYPICAL NOTES

2

PROJECT: 12th DISTRICT POLICE STATION  
 MATRIX #: 09018

ISSUE: ADDENDUM 2  
 TITLE: TYPICAL DETAIL AT BOLLARD  
 REFERENCE: S2.4



COMMENTS:

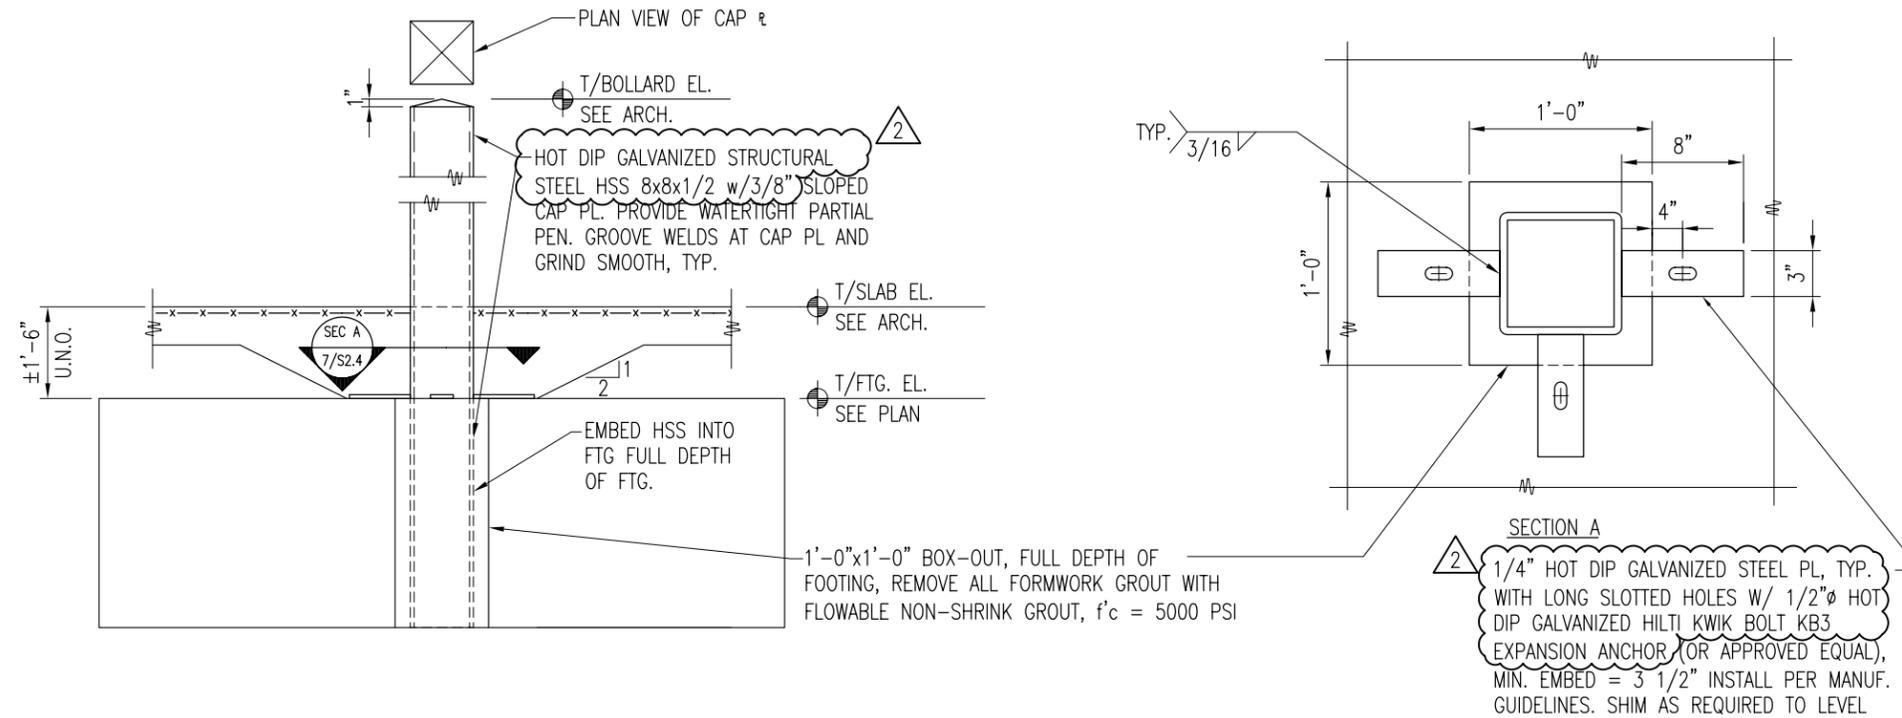

7 TYPICAL DETAIL AT BOLLARD  
 S2.4 1/2"=1'-0"

DATE 07/09/10

**SSK-10**

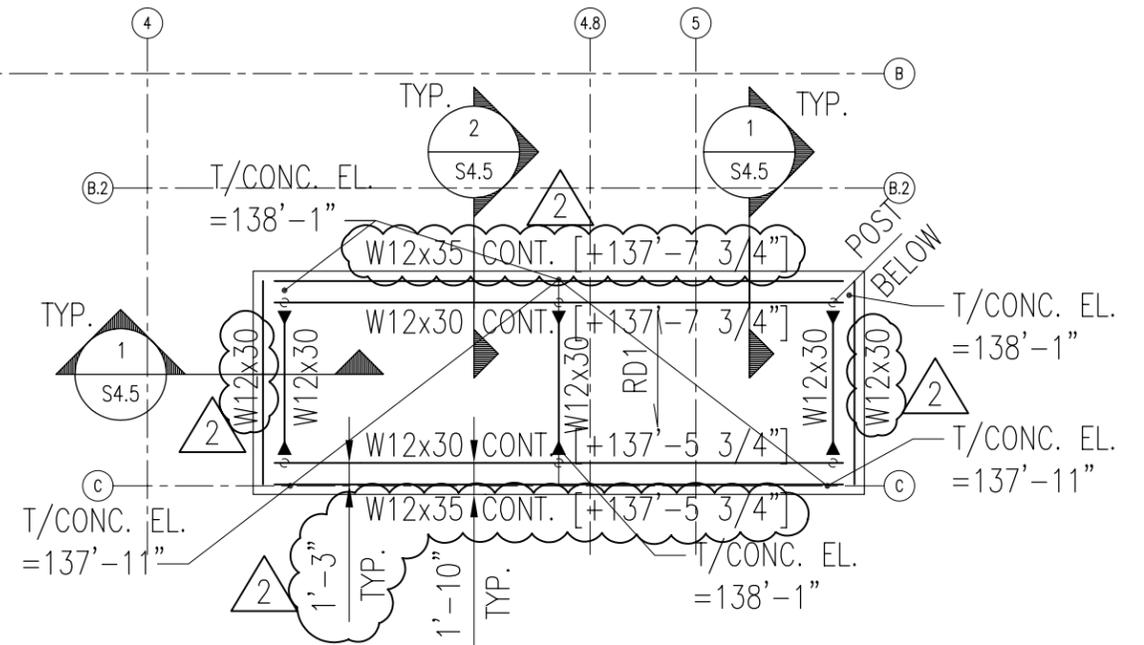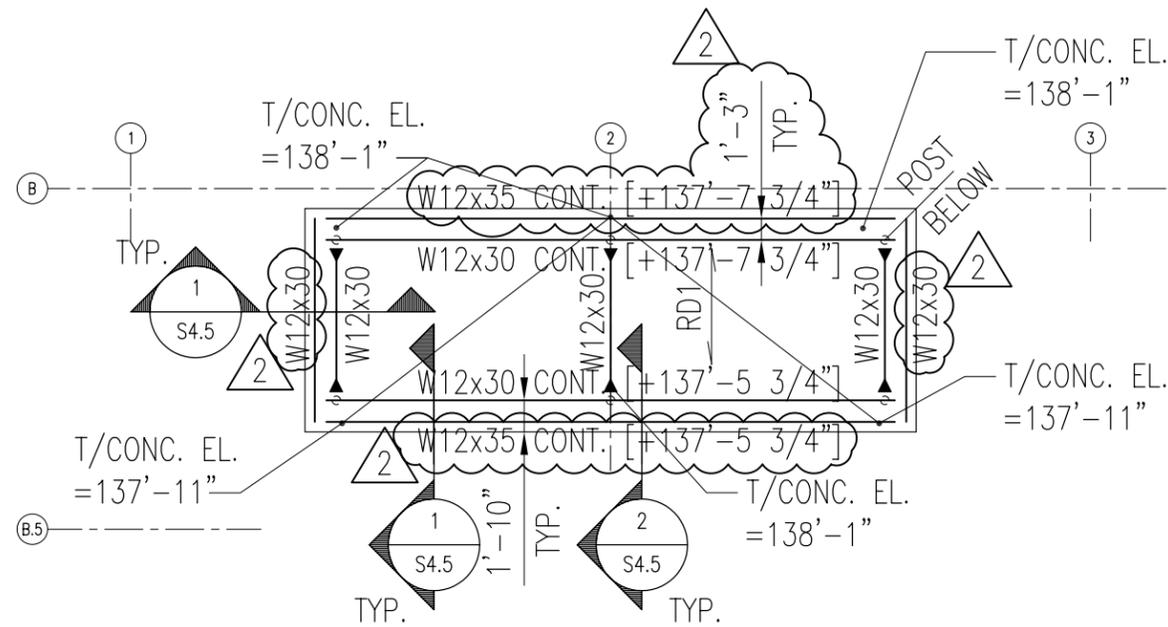

**LIGHT MONITOR ROOF PARTIAL PLAN**  
 3/32" = 1'-0"



NOTES:

1. VERIFY ALL DIMENSIONS AND ELEVATIONS WITH ARCH. DWGS. PRIOR TO CONSTRUCTION.
2. SEE S0.1 & S0.2 FOR GENERAL STRUCTURAL NOTES. FOR TYPICAL SLAB ON DECK CONSTRUCTION AND STEEL CONNECTIONS, SEE SHTS. S4.2 AND S4.3.
3. RD1 2"x18GA. GALV. COMPOSITE FLOOR DECK W/3 1/4" LIGHT -WEIGHT CONCRETE (5 1/4" TOTAL THICKNESS) W/STEEL FIBERS @ 25 LBS/CU. YARD OF CONCRETE.

PROJECT: 12th DISTRICT POLICE STATION  
MATRIX #: 09018

ISSUE: ADDENDUM 2  
TITLE: SECTION(S) AT LIGHT MONITOR  
REFERENCE: S2.5

COMMENTS:

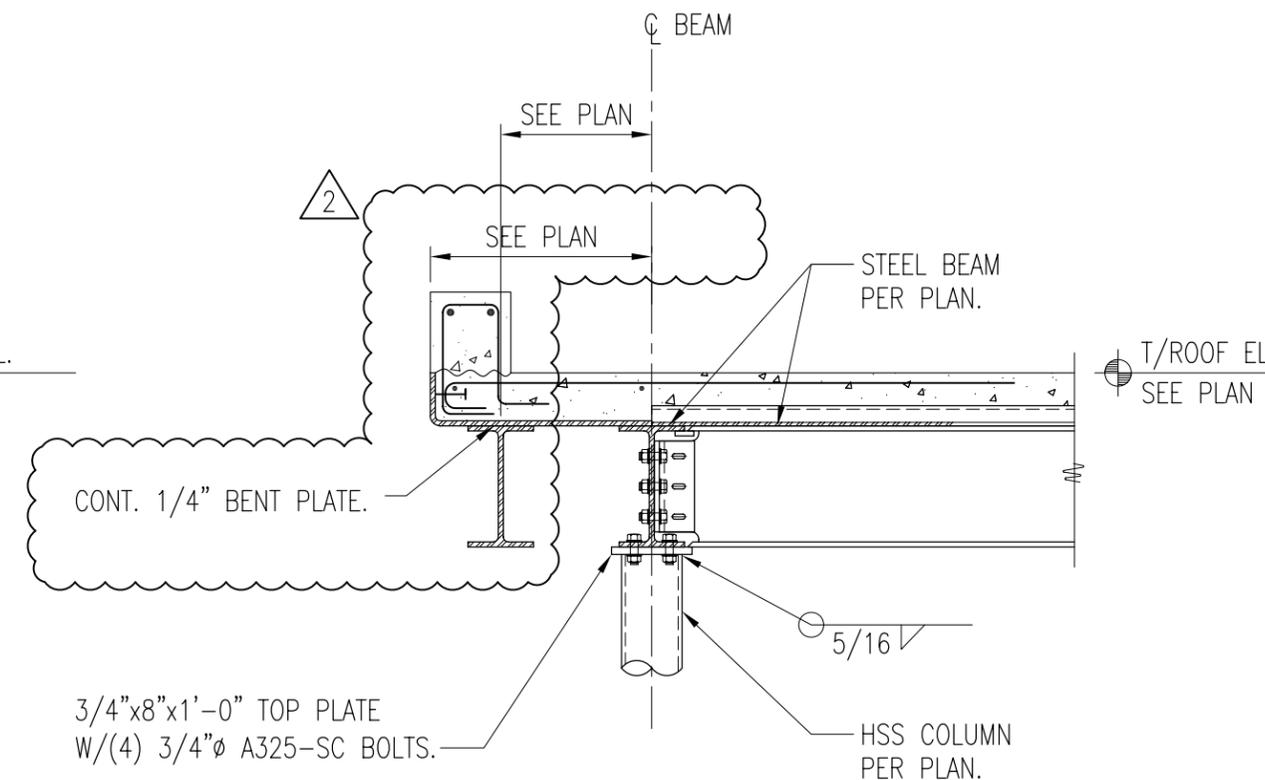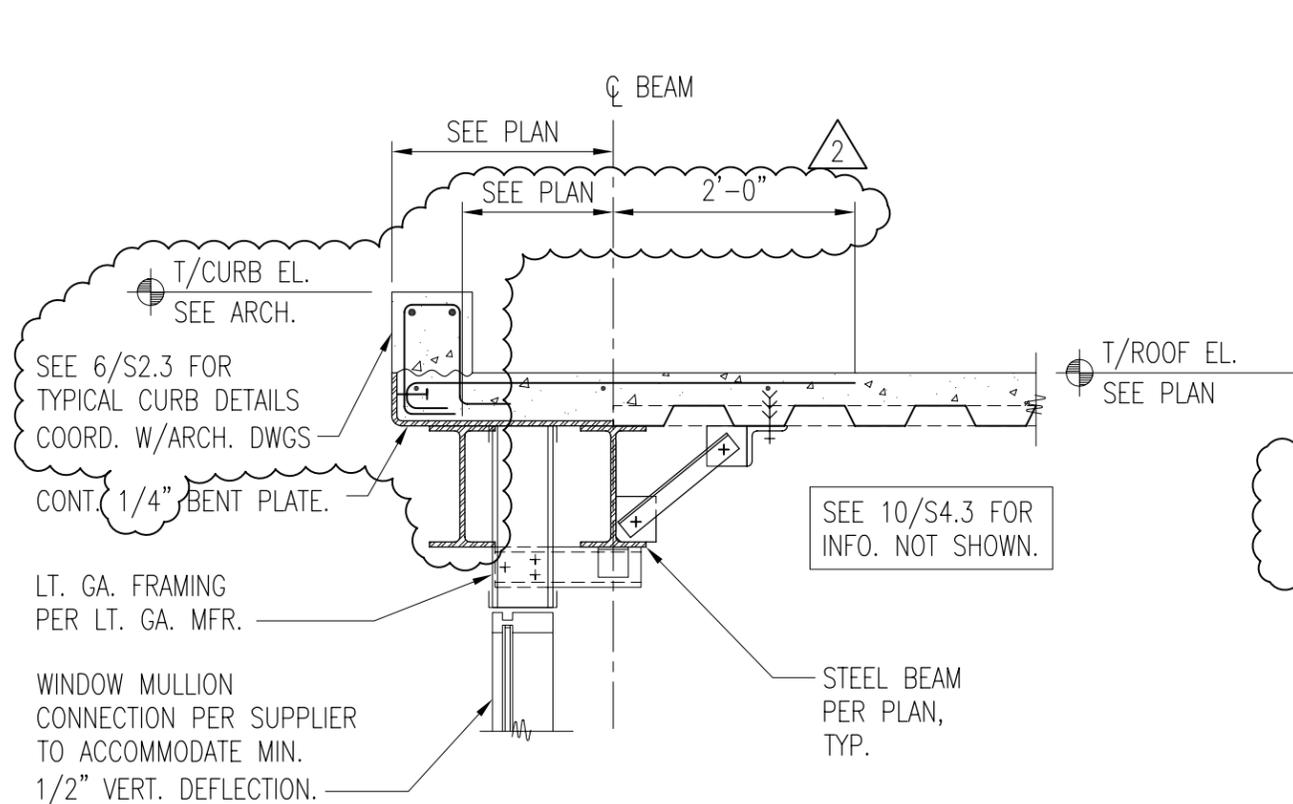

SEE 9/S4.2 & 10/S4.3  
FOR INFO. NOT SHOWN.  
SEE 1/S4.5 FOR MORE  
INFORMATION.


**1 SECTION AT LIGHT MONITOR**  
S4.5 3/4"=1'-0"

**2 SECTION AT LIGHT MONITOR**  
S4.5 3/4"=1'-0"

DATE 07/09/10

**SSK-12**



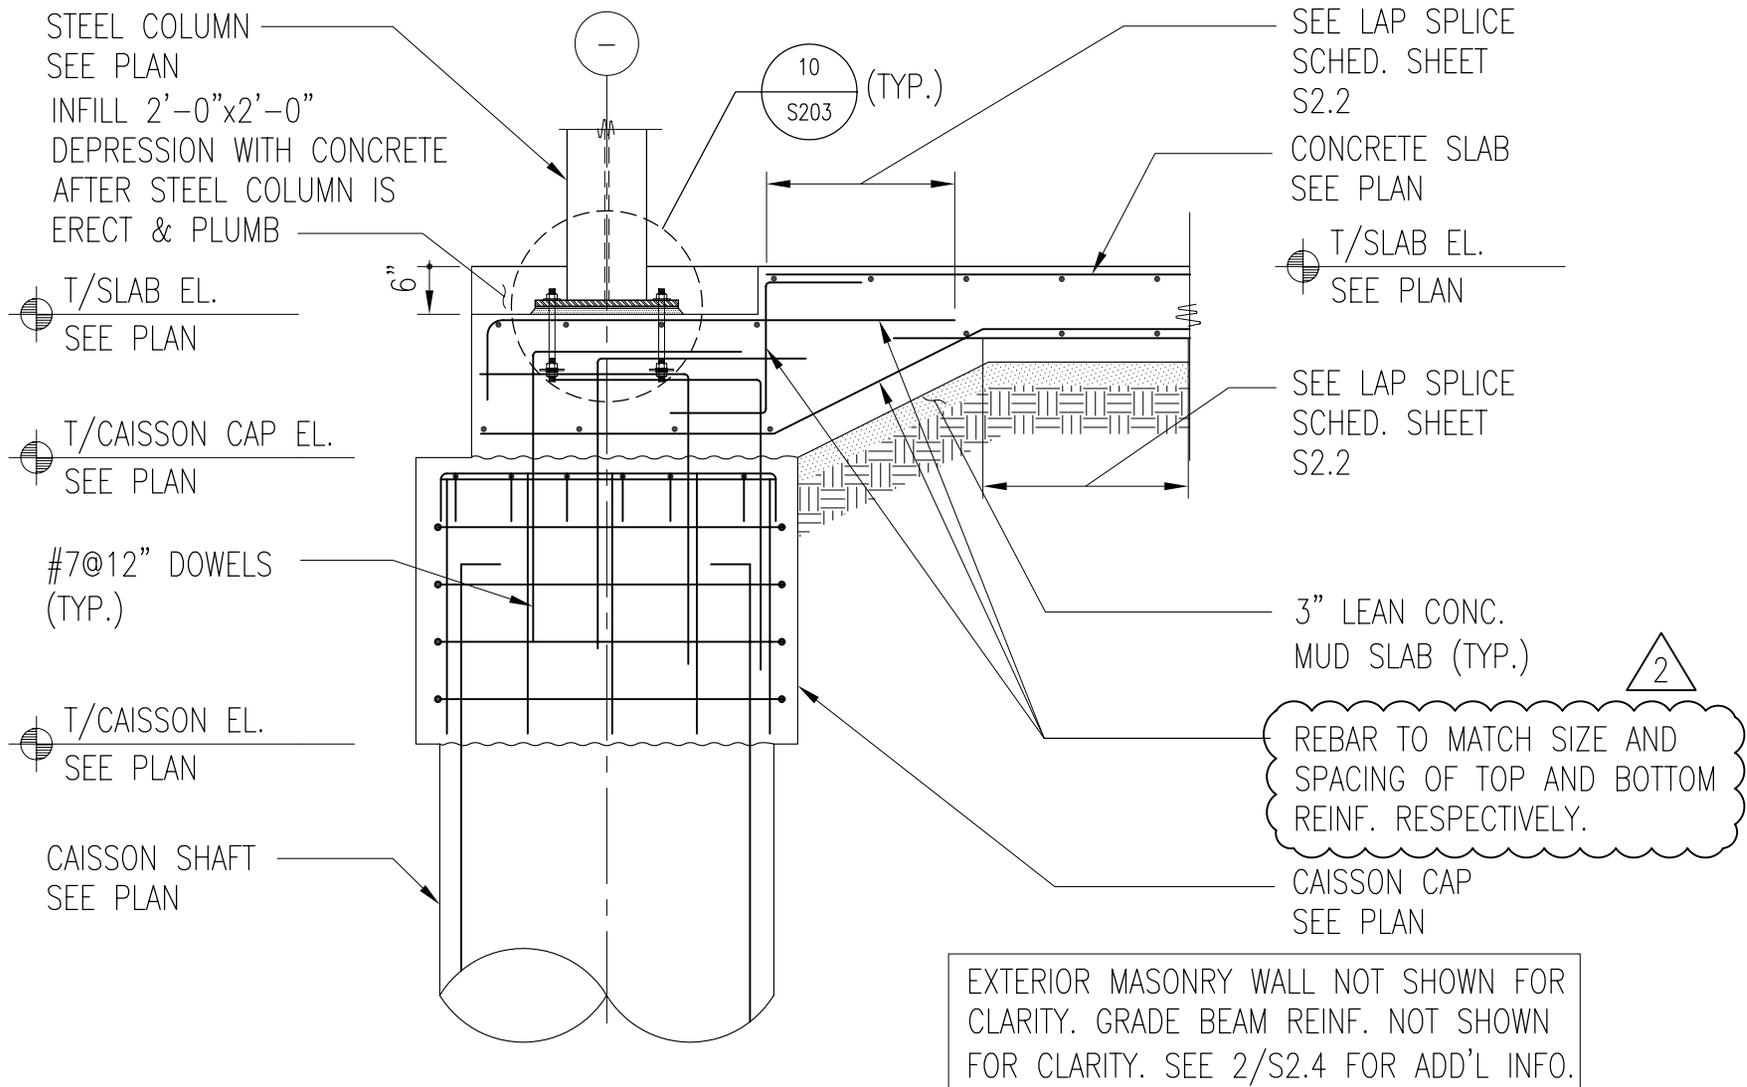

1  
S2.4

**TYP. SECTION AT EXTERIOR CAISSON CAP**

1/2" = 1'-0"

**MATRIX**

Matrix Engineering Corporation  
Structural Engineers  
33 W. Jackson Blvd 4th floor  
Chicago Illinois 60604-3901  
v 312 427 1200  
f 312 427 4220

PROJECT: **12th DISTRICT POLICE STATION** 1412 S. BLUE ISLAND AVENUE CHICAGO, IL 60608  
MATRIX #: 09018  
ISSUE: ADDENDUM 2  
TITLE: TYPICAL SECTION AT EXTERIOR CAISSON CAP  
REFERENCE: S2.4  
COMMENTS:


**SSK-14**

DATE: 07/09/10







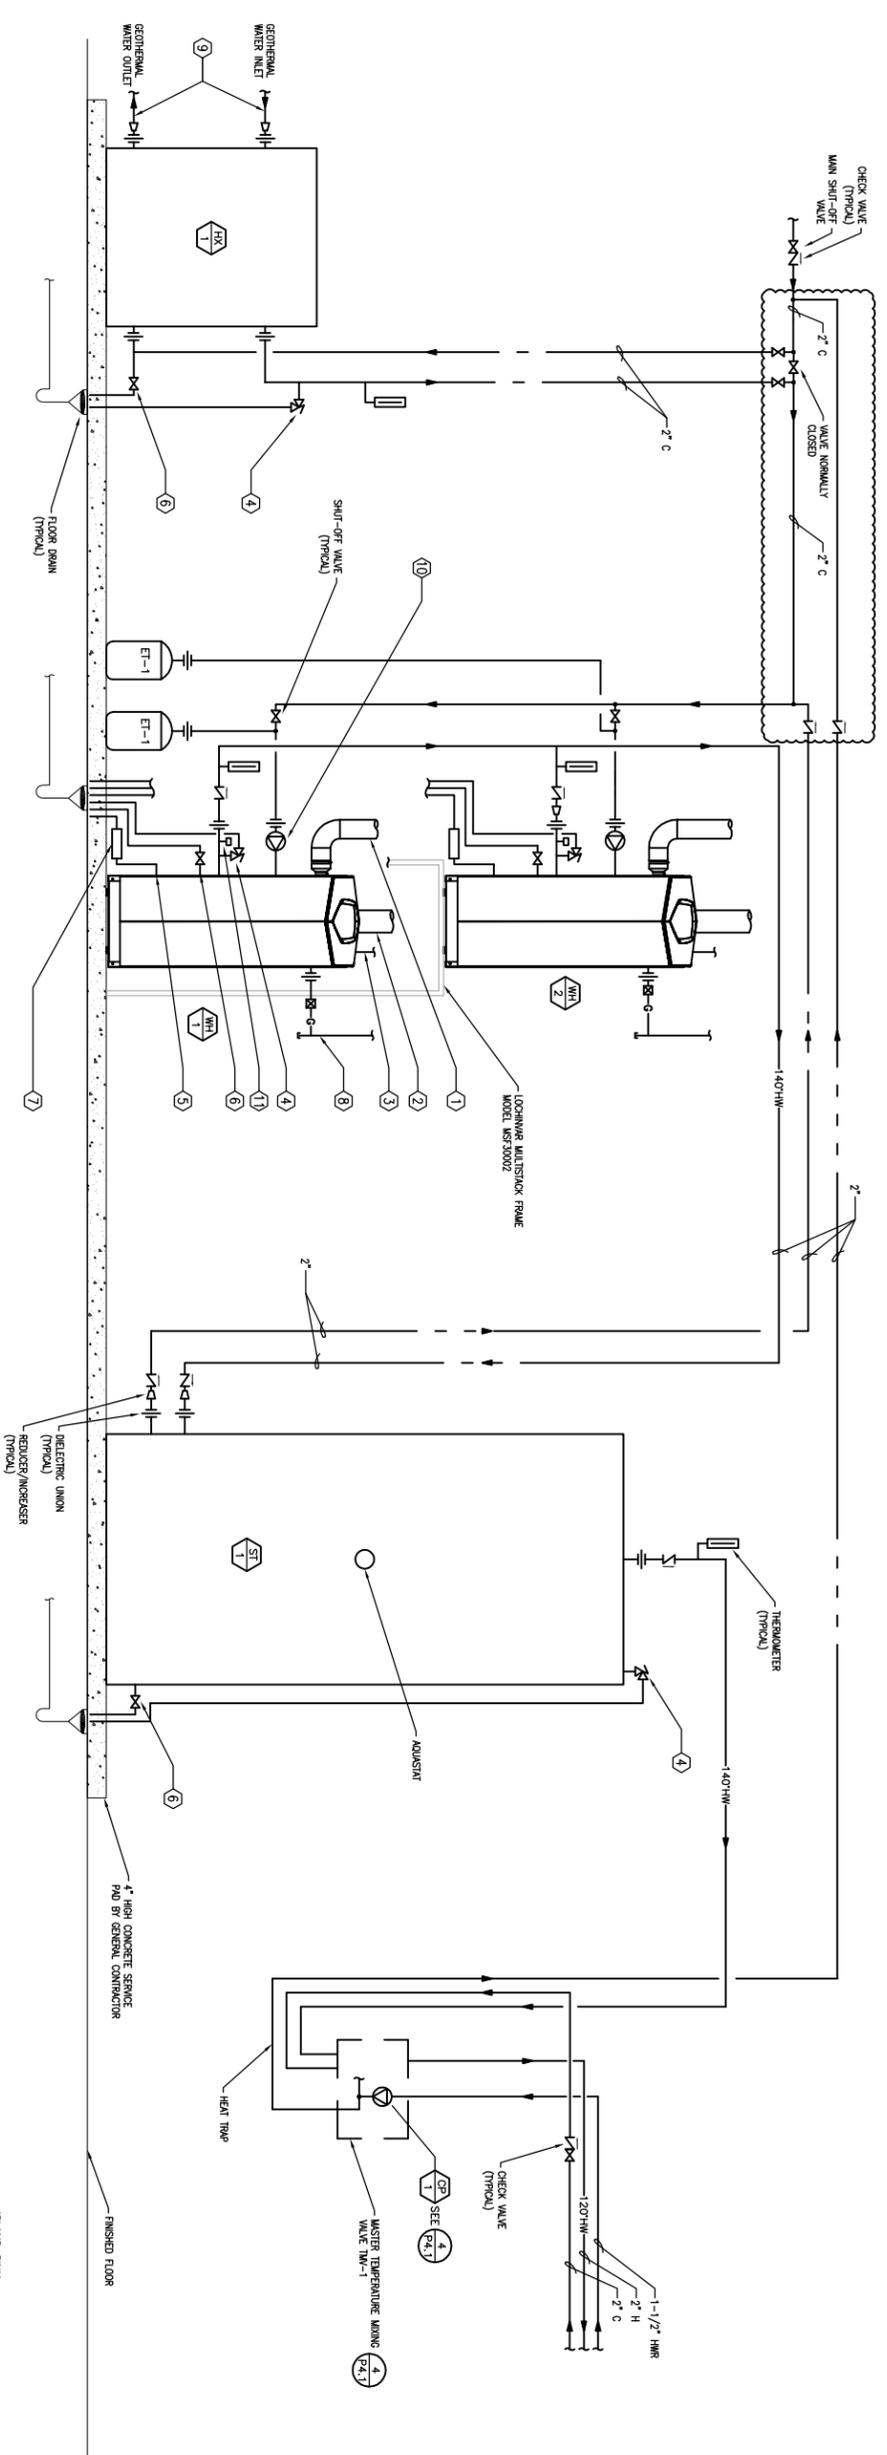


**KEYED NOTES:**

- ① STAINLESS STEEL CATEGORY 4 POSITIVE PRESSURE VENT TO OUTSIDE BY HVAC CONTRACTOR. SEE PLAN FOR CONNECTION. (TYPICAL EACH HEATER)
- ② INSULATED STAINLESS STEEL COMBUSTION AIR INTAKE DUCT BY HVAC CONTRACTOR. SEE PLAN FOR CONNECTION. (TYPICAL EACH HEATER)
- ③ 120V/14 AMPER SUPPLY BY ELECTRICAL CONTRACTOR (TYPICAL EACH HEATER)
- ④ PIPING WITH FULL SIZE PIPE OVER FLOOR DRAIN WITH APPROVED AIR GAP (TYPICAL)
- ⑤ CONDENSATE CONNECTION WITH FULL SIZE PVC PIPE OVER FLOOR DRAIN WITH APPROVED AIR GAP (TYPICAL)
- ⑥ TANK DRAIN CONNECTION WITH FULL SIZE PIPE OVER FLOOR DRAIN WITH APPROVED AIR GAP (TYPICAL)
- ⑦ CONDENSATE AIRBRAKER KIT PROVIDED BY HEATER MANUFACTURER (TYPICAL)
- ⑧ NATURAL GAS CONNECTION. SEE HVAC DRAWINGS (TYPICAL)
- ⑨ GEOTHERMAL LOOP CONNECTION. SEE HVAC DRAWINGS (TYPICAL)
- ⑩ WATER HEATER INTEGRAL ALL BRONZE CIRCULATING PUMP (TYPICAL)
- ⑪ WATER HEATER FLOW SWITCH (TYPICAL)

**NOTES:**

1. PROVIDE MANUAL ON/OFF SWITCH FOR RECIRCULATING PUMP G-1.
2. COORDINATE ELECTRICAL REQUIREMENTS WITH ELECTRICAL CONTRACTOR PRIOR TO CONSTRUCTION.
3. ALL GEOTHERMAL WATER PIPING AND TANK BY MECHANICAL CONTRACTOR. ALL POSITIVE WATER AND DRAIN PIPING AND TRIM BY PLUMBING CONTRACTOR.

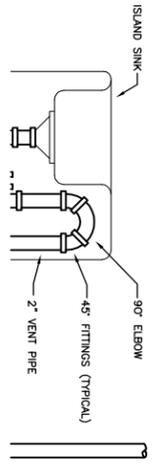

**1 CONDENSING DOMESTIC WATER HEATER DETAIL**  
SCALE: N.T.S.


Description: ADDENDUM #2 - PLUMBING DETAILS	
Project Number: 2009062	Scale: N.T.S.
Drawn by: BDT	Checked: JEF

**Primera**  
100 S. WACKER DRIVE SUITE 700 · CHICAGO IL 60606  
P.312.606.0910 F.312.606.0415

Project Name: POLICE DEPARTMENT DISTRICT 12	Date: 07-02-2010
	Approved: JEF

Reference: <b>P4.2</b>
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Sketch No. <b>PSK-13</b>
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\*NOTE: PROVIDED BY DIVISION 02805.

SEE 4 C4.1
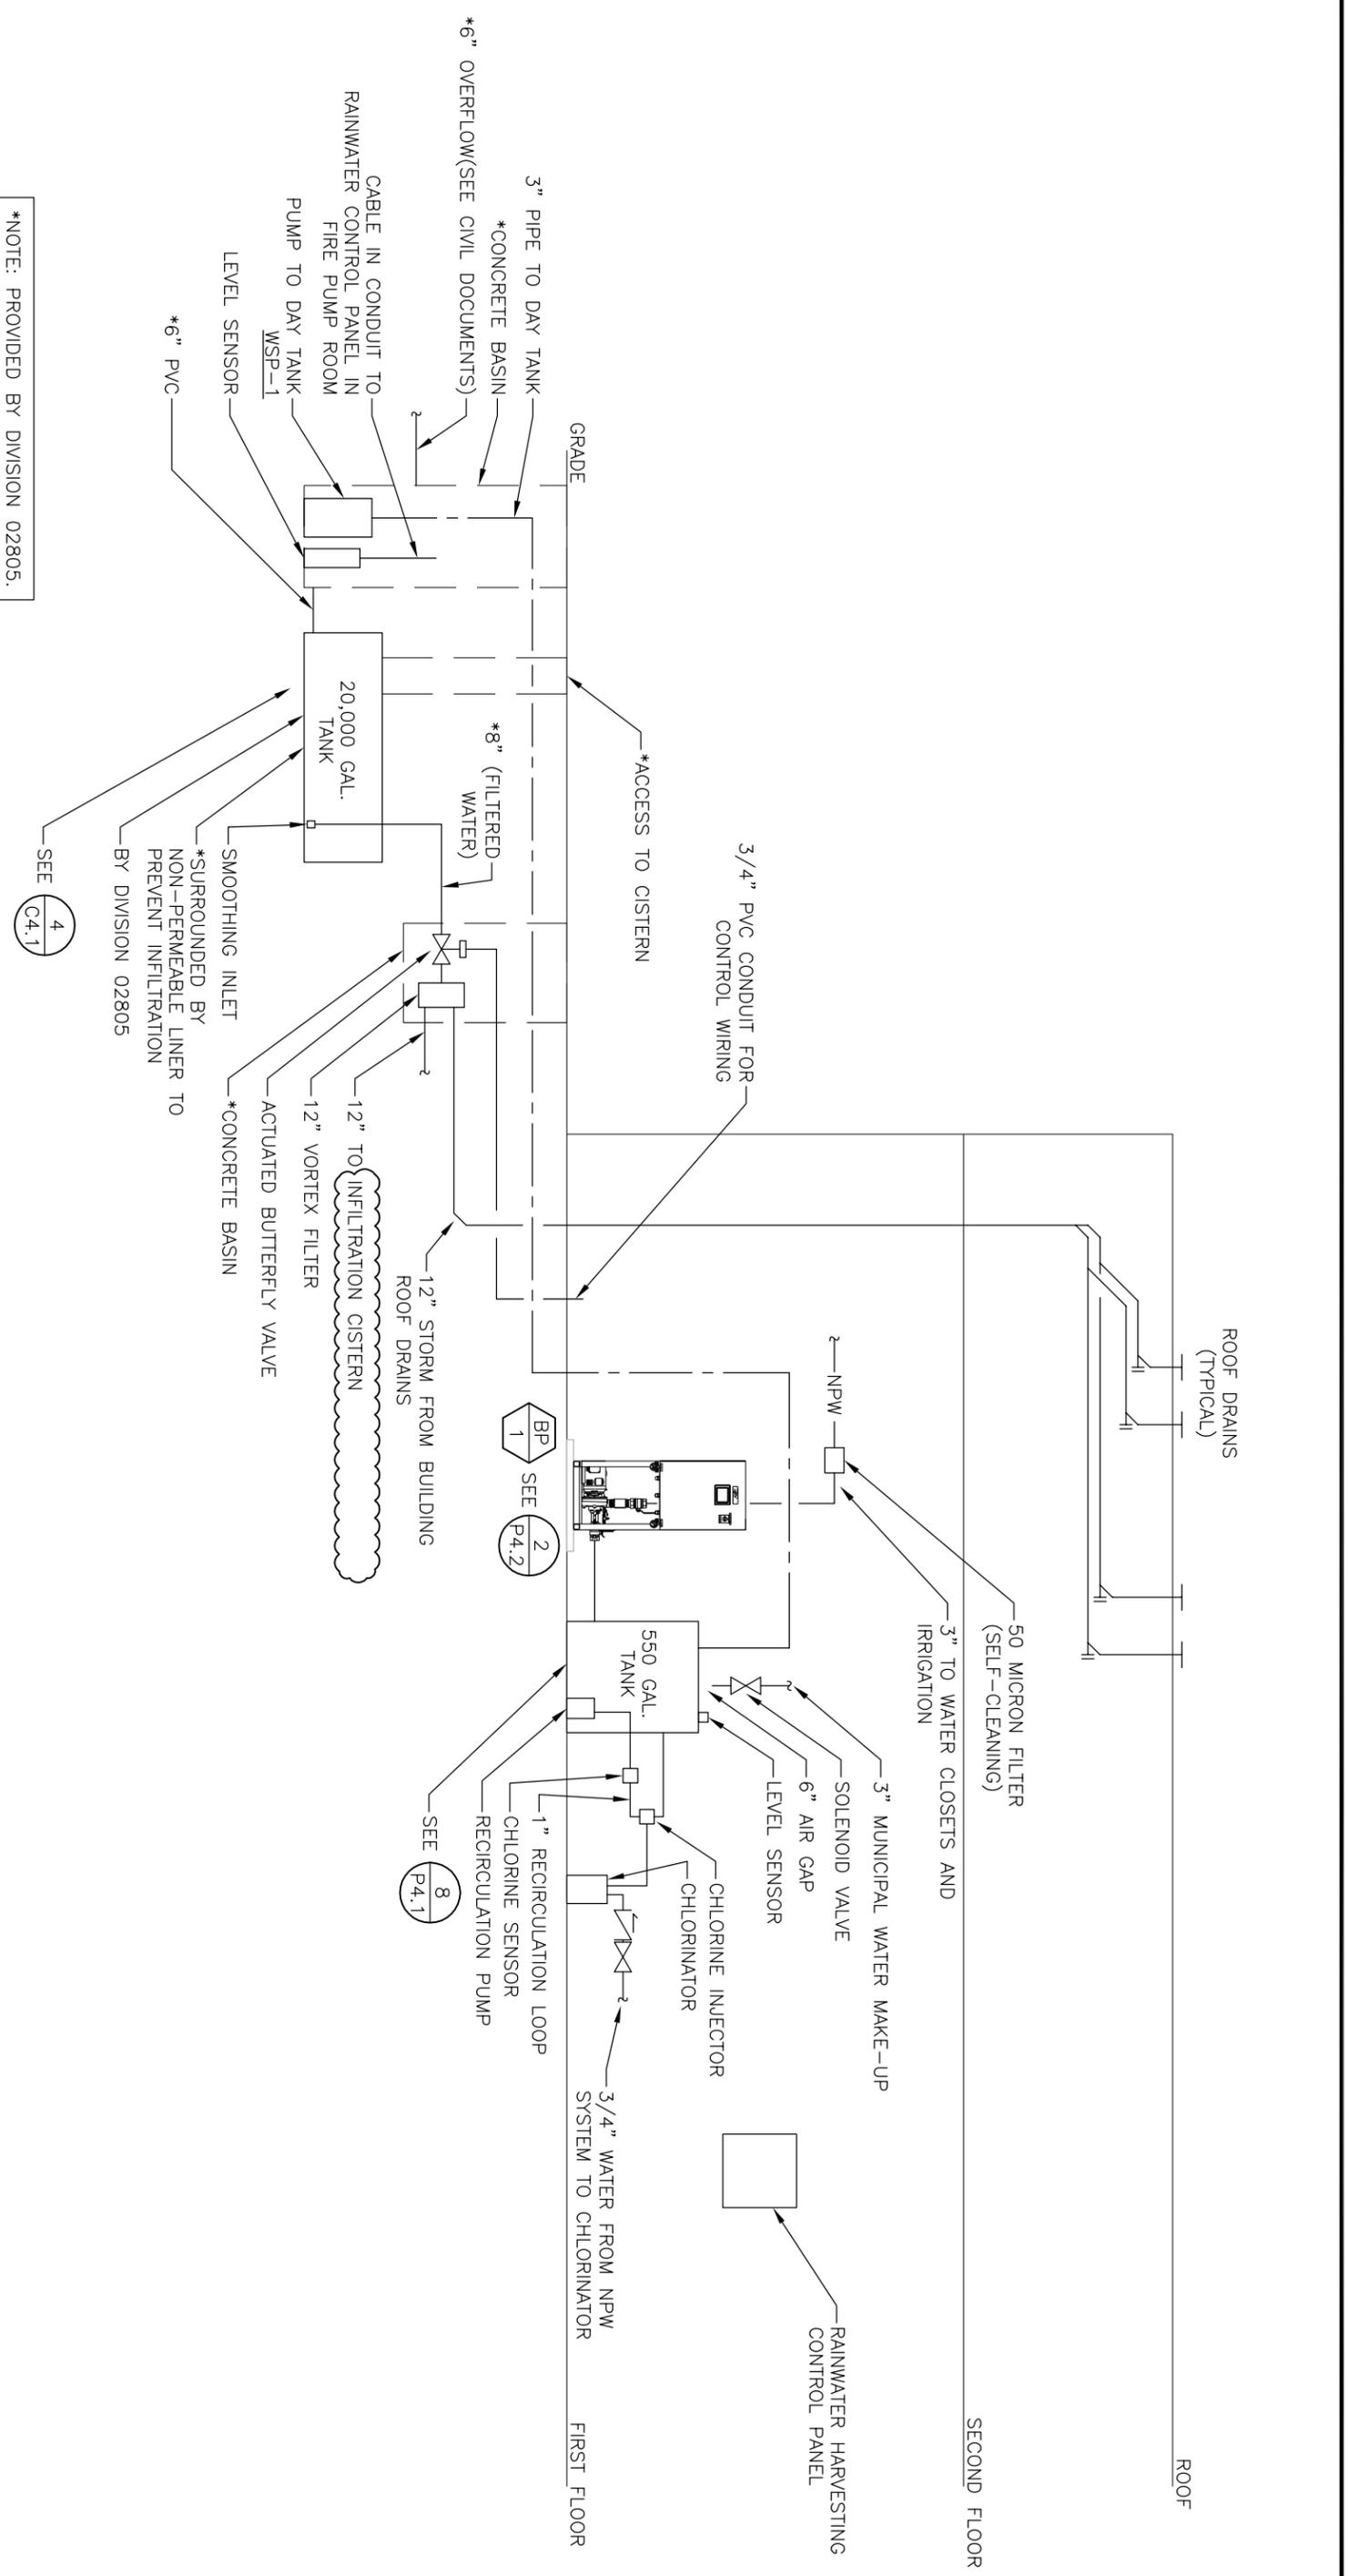
# 1 RAINWATER HARVESTING DIAGRAM


SCALE: N.T.S.

Description: ADDENDUM #2 - PLUMBING DETAILS	
Project Number: 2009062	Scale: N.T.S.
Drawn by: BDT	Checked: JEF

Project Name:	POLICE DEPARTMENT DISTRICT 12
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Reference:	P4.3
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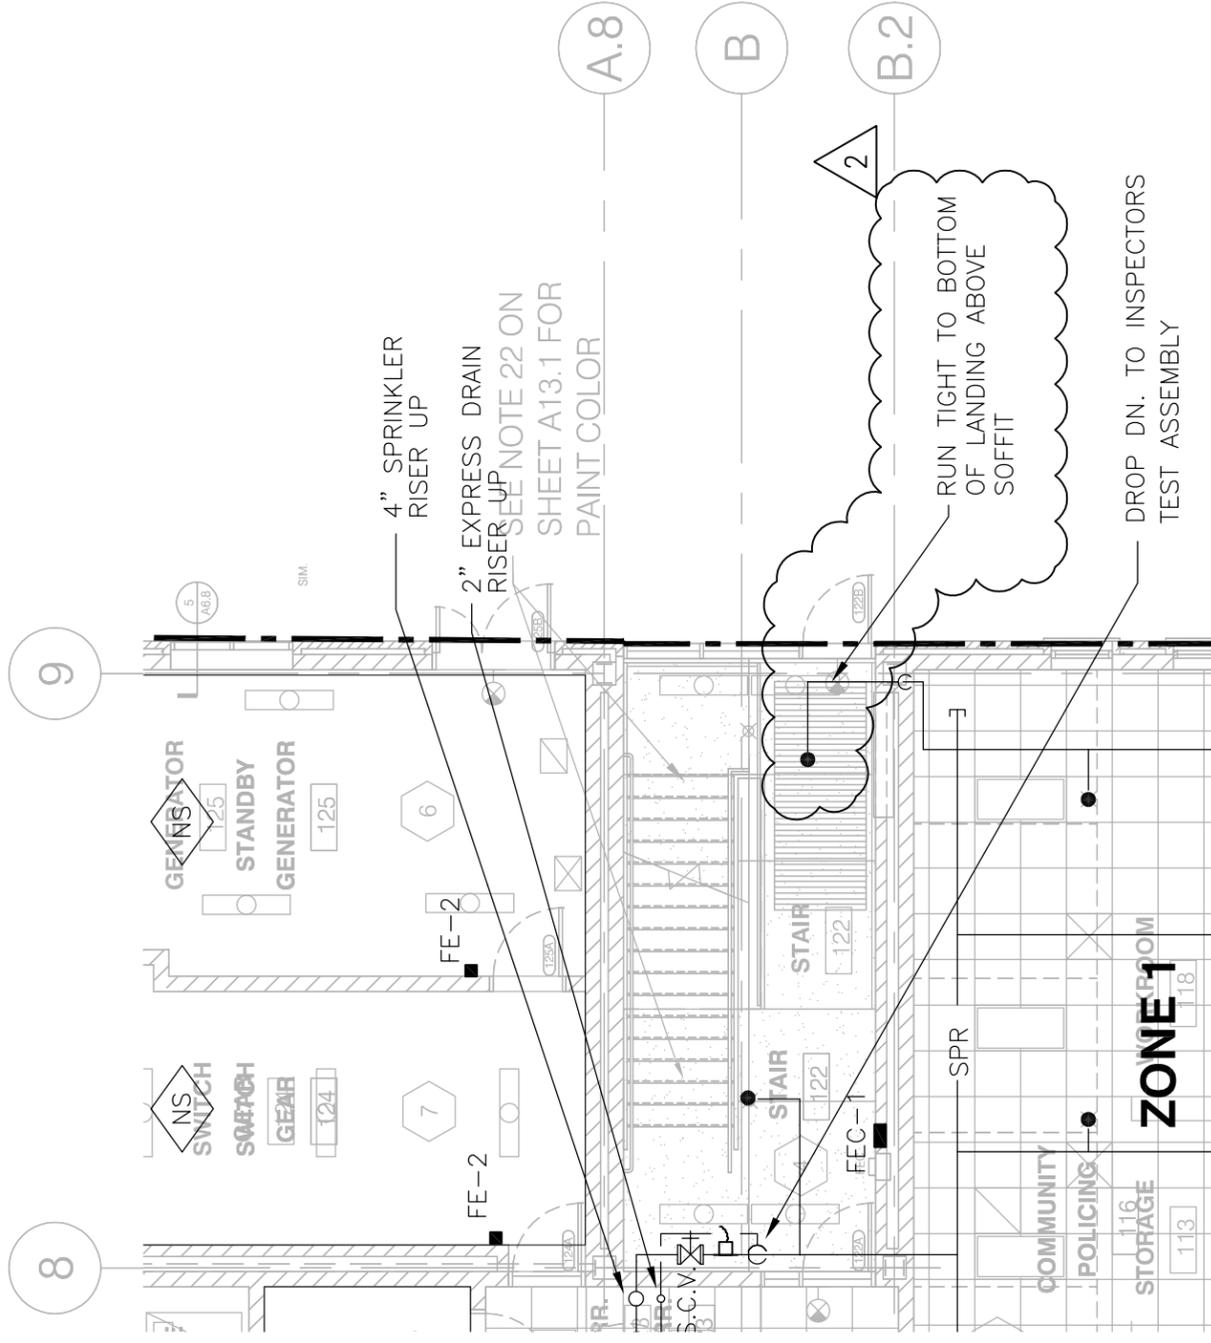
Sketch No.	PSK-14
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NOTES:  
 1. 2" NPW TO INCLUDE PRV-1.  
 2. (2) 1" NPW TO INCLUDE PRV-2

DUAL DOMESTIC WATER METER ARRANGEMENT. METERS ARE BY PLUMBING CONTRACTOR.

Description: ADDENDUM #2 - PLUMBING ENLARGED PLANS	Project Name: POLICE DEPARTMENT DISTRICT 12	Reference: P6.1	Sketch No. PSK-15
Project Number: 2009062	Date: 07-02-2010	Approved: JEF	Reference: P6.1
Drawn by: BDT	Scale: 1/8"-1'-0"	Checked: JEF	Reference: P6.1

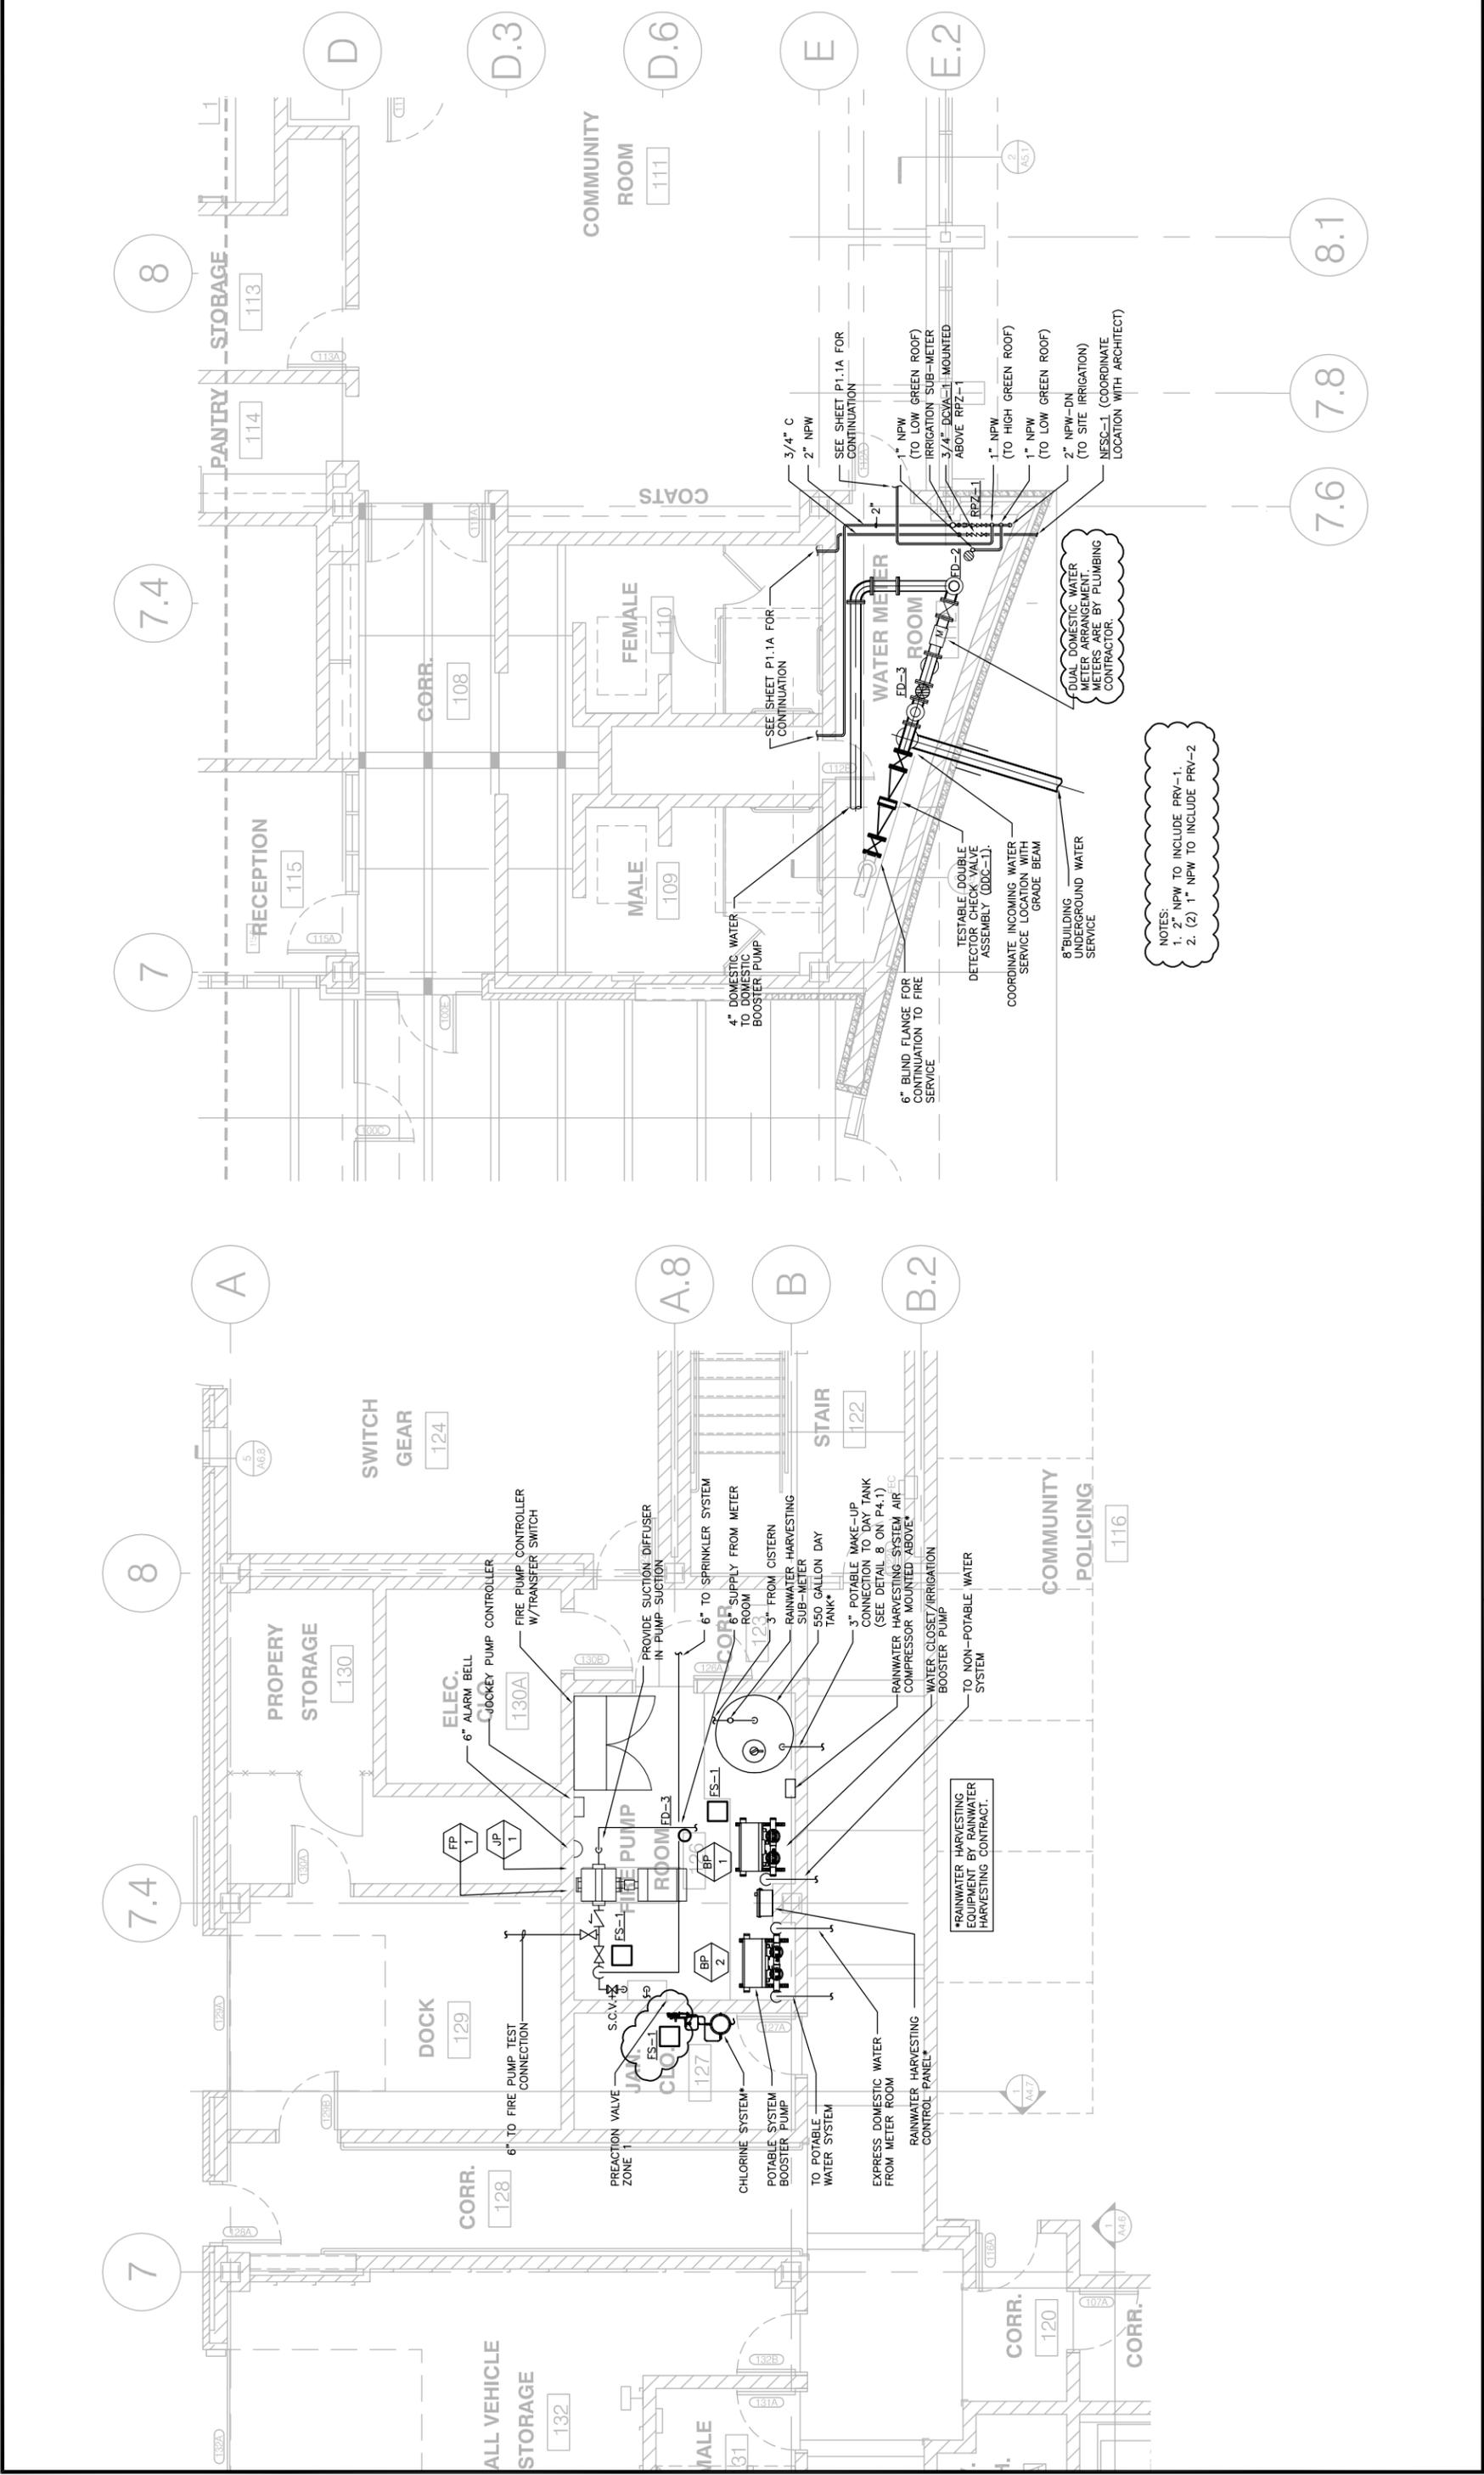

Description: ADDENDUM #2 - FIRE PROTECTION FIRST FLOOR PLAN

Project Number: 2009062

Scale: 1/8" = 1'-0"

Date: 07-02-2010

Drawn by: MK

Checked: JEF

Approved: JEF



Project Name:  
POLICE  
DEPARTMENT  
DISTRICT 12

Reference:  
FP1.1

Sketch No.  
FPSK-01